
# SYD08 DATA CENTRE

CIVIL SERVICES

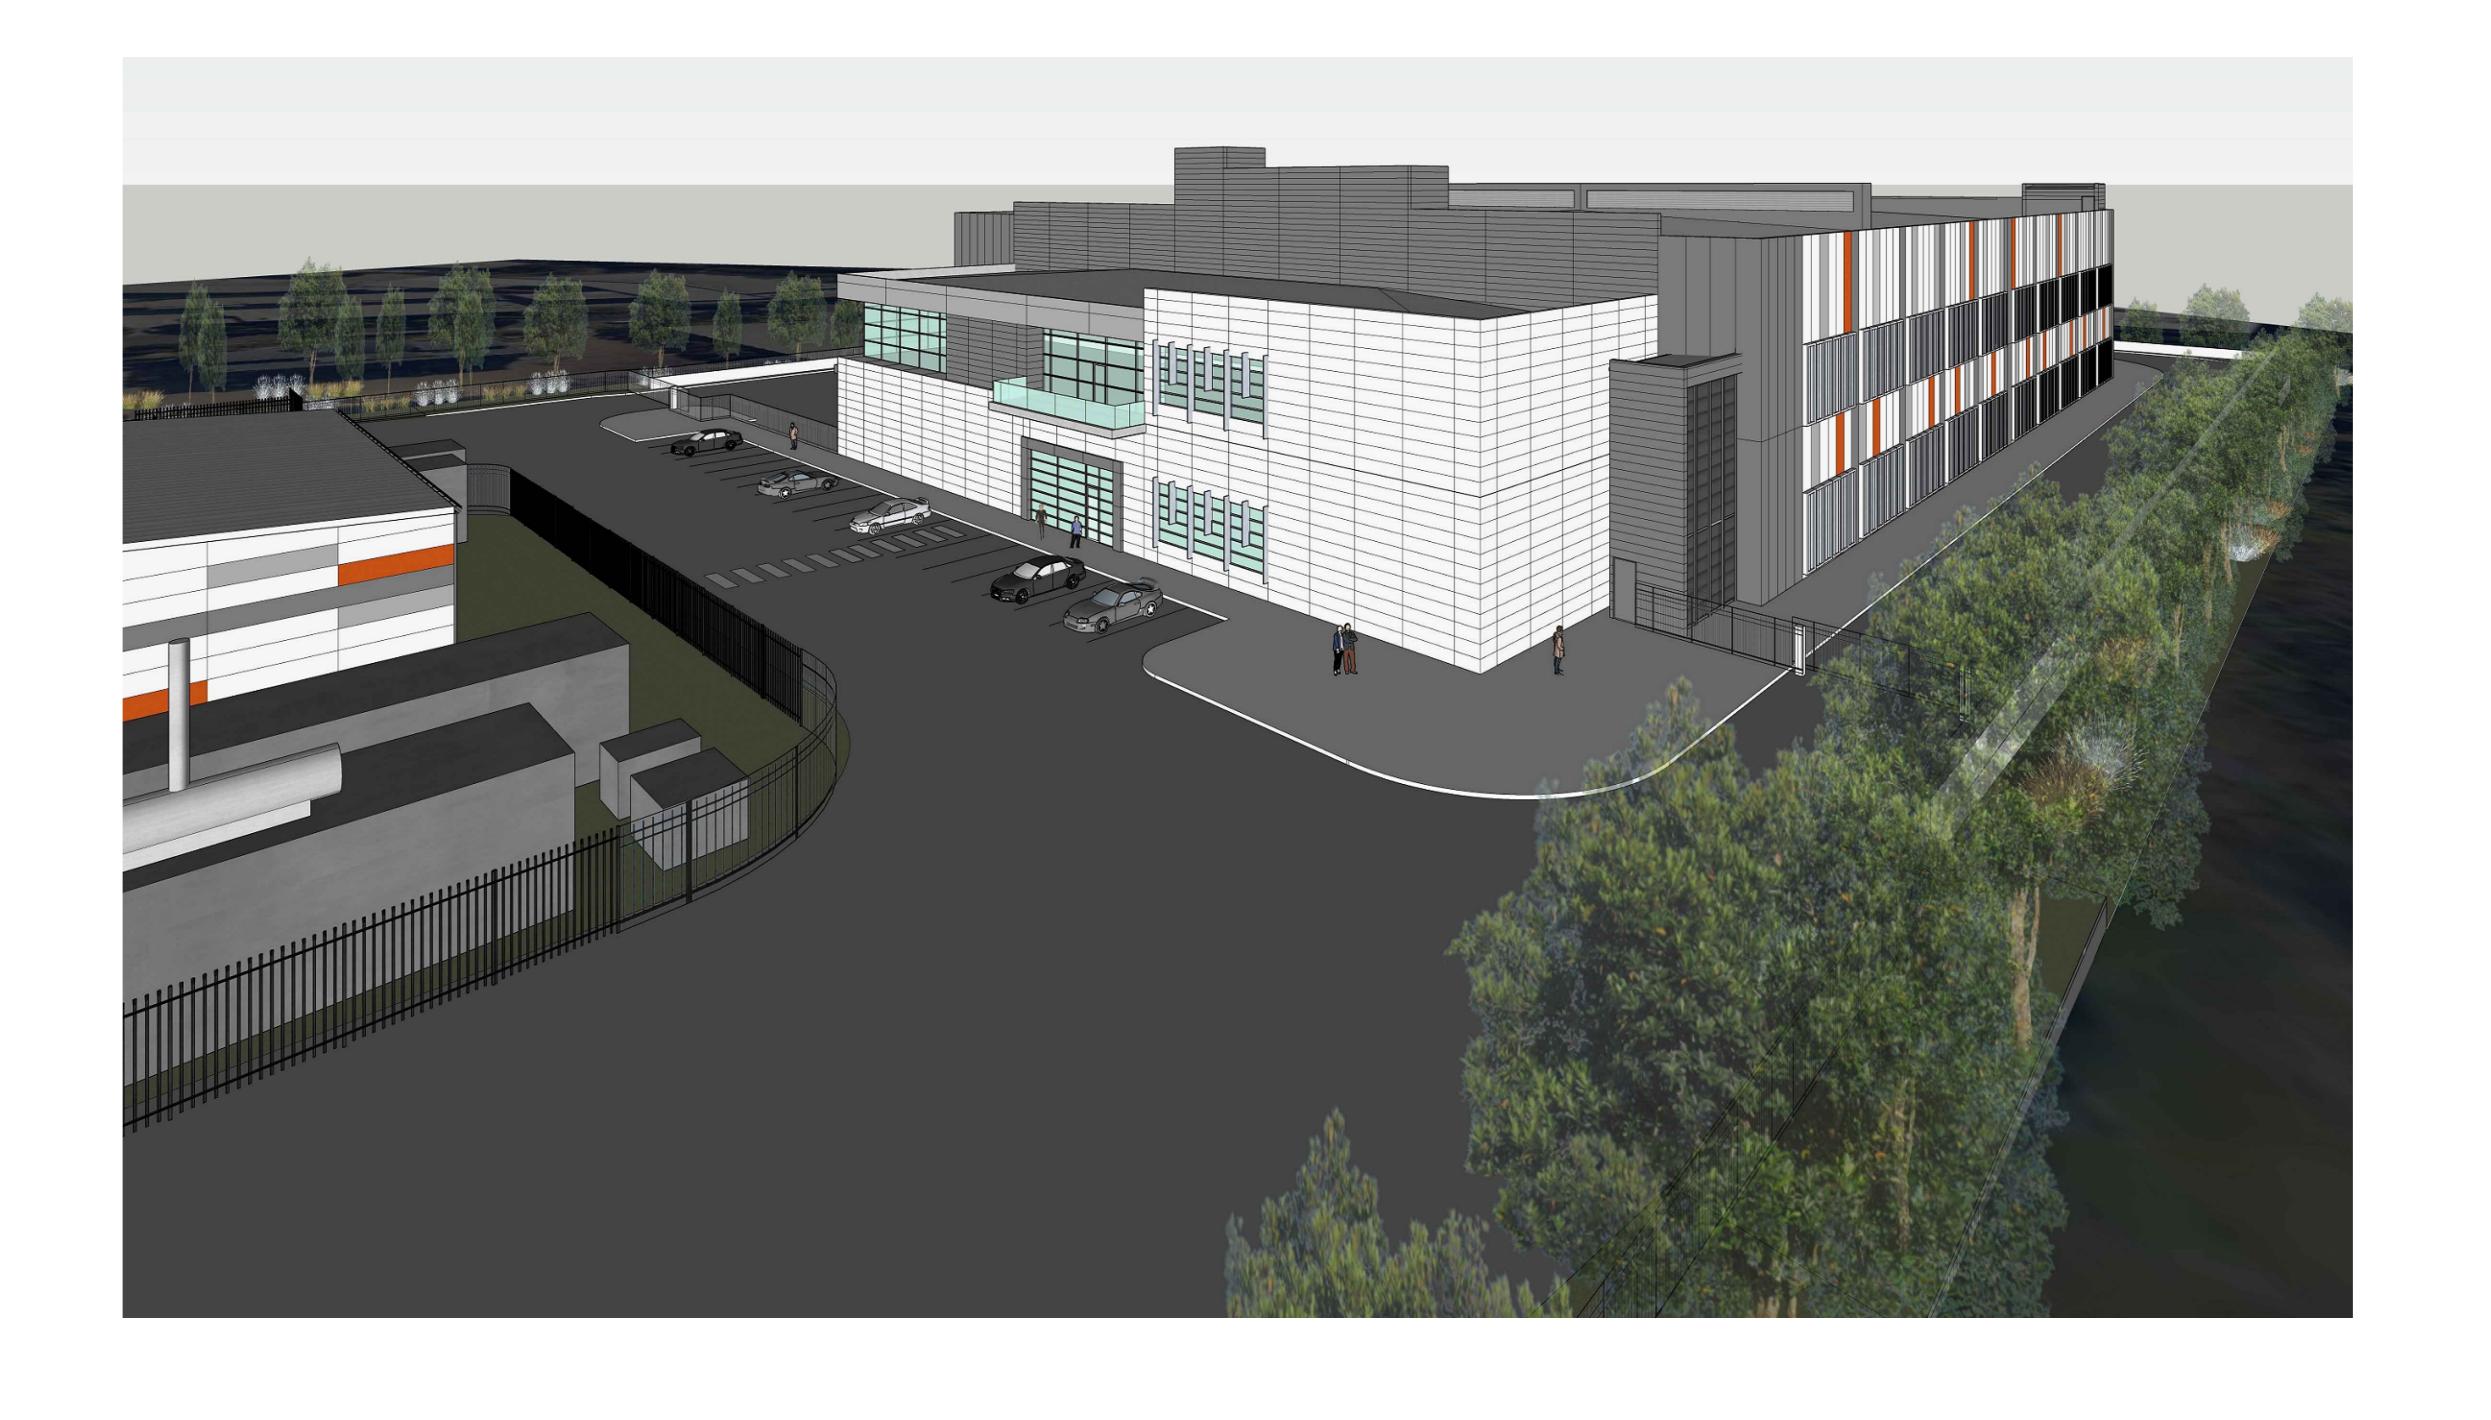

CIVIL DRAWING LIST

Ë A0

NSW202013\_C101.01 COVER SHEET AND DRAWING LIST NSW202013\_C101.02 LEGENDS SHEET NSW202013\_C101.03 NSW202013\_C101.05 **DETAILS SHEET 1** NSW202013\_C101.06 DETAILS SHEET 2 NSW202013\_C101.07 DETAILS SHEET 3

NSW202013\_C101.08 **DETAILS SHEET 4** NSW202013\_C101.10 GENERAL ARRANGEMENT AND PHASING PLAN

NSW202013\_C103.01 CIVIL WORKS PLAN NSW202013\_C103.10 STORMWATER CATCHMENT PLAN


NSW202013\_C103.11 WATER BALANCE CATCMENT PLAN NSW202013\_C105.01 SOIL AND WATER MANAGEMENT PLAN NSW202013\_C107.01 VEHICLE TURN PATHS PLAN

B ISSUE FOR SSDA 14.03.22 RG MB A ISSUE FOR SSDA Date By Chk

Lead Consultant / MEP / Structures

LCI CONSULTANTS (AUSTRALIA) PTY LTD



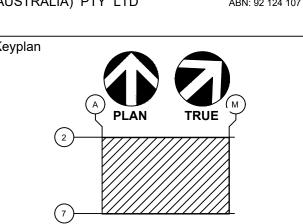

SYD08 DATA CENTRE 57 STATION ROAD SEVEN HILLS, NSW 2147


Drawing Title
COVER SHEET AND DRAWING LIST


ISSUE FOR SSDA Scale @ A0


NSW202013\_C101.01

Drawing No.

DIAL BEFORE YOU DIG DIAL BEFORE TO MAINTAIN A CURRENT SET OF "DIAL BEFORE YOU DIG" DRAWINGS ON SITE AT ALL TIMES.

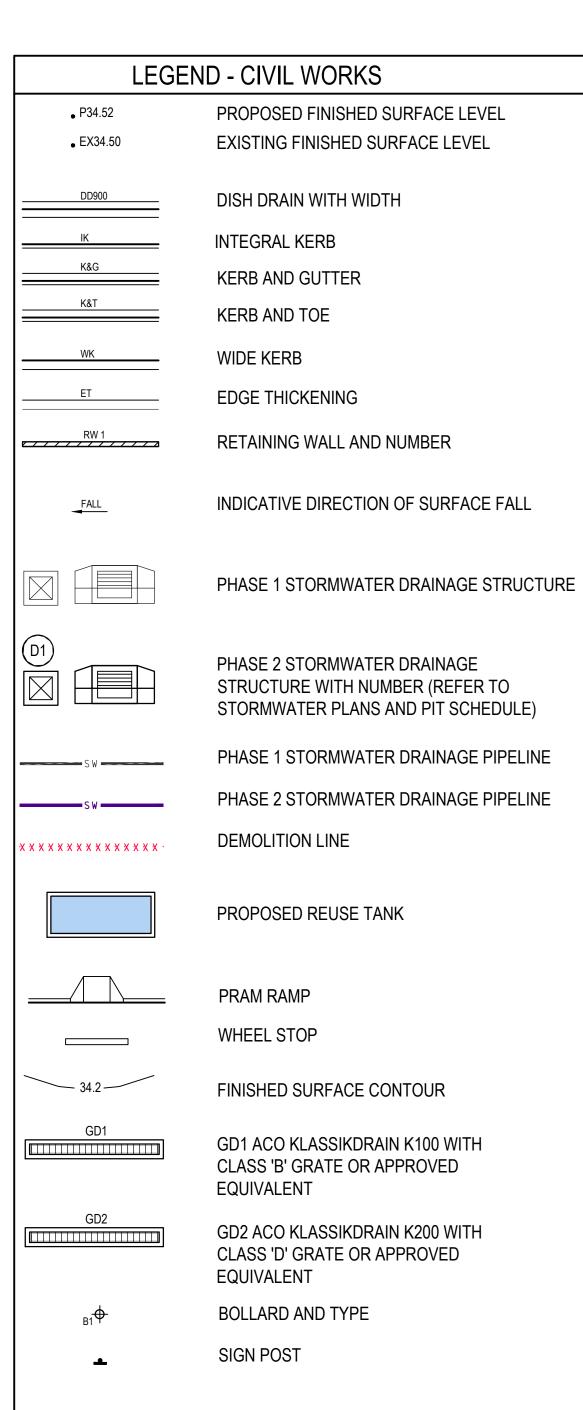

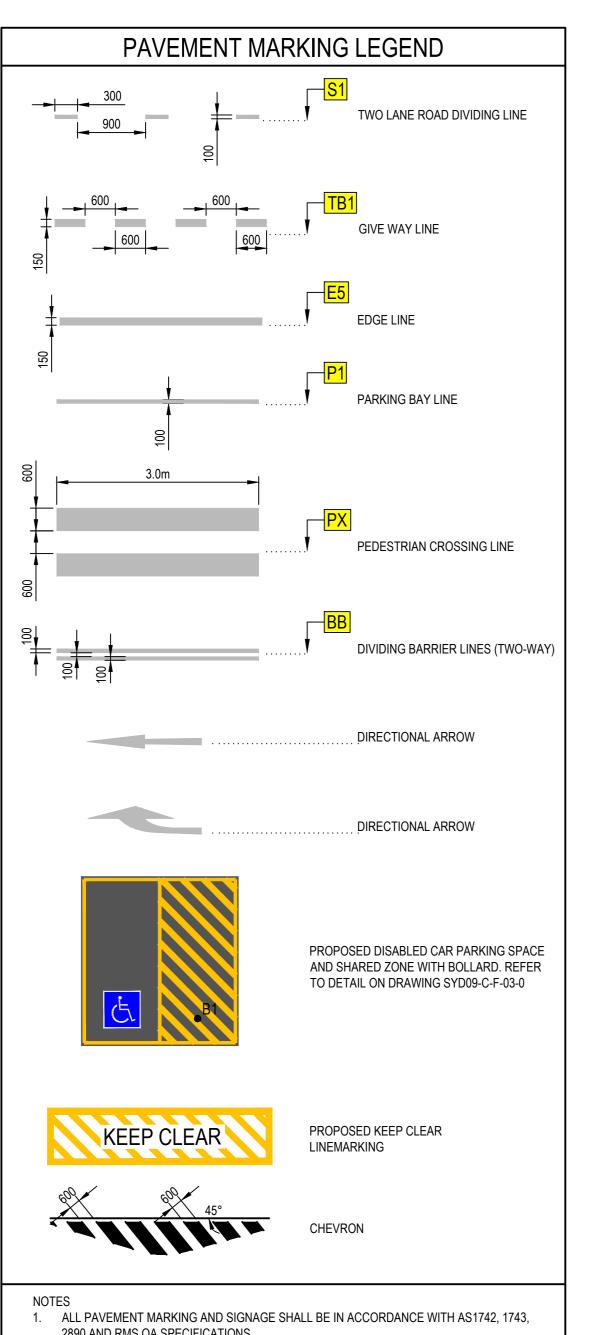


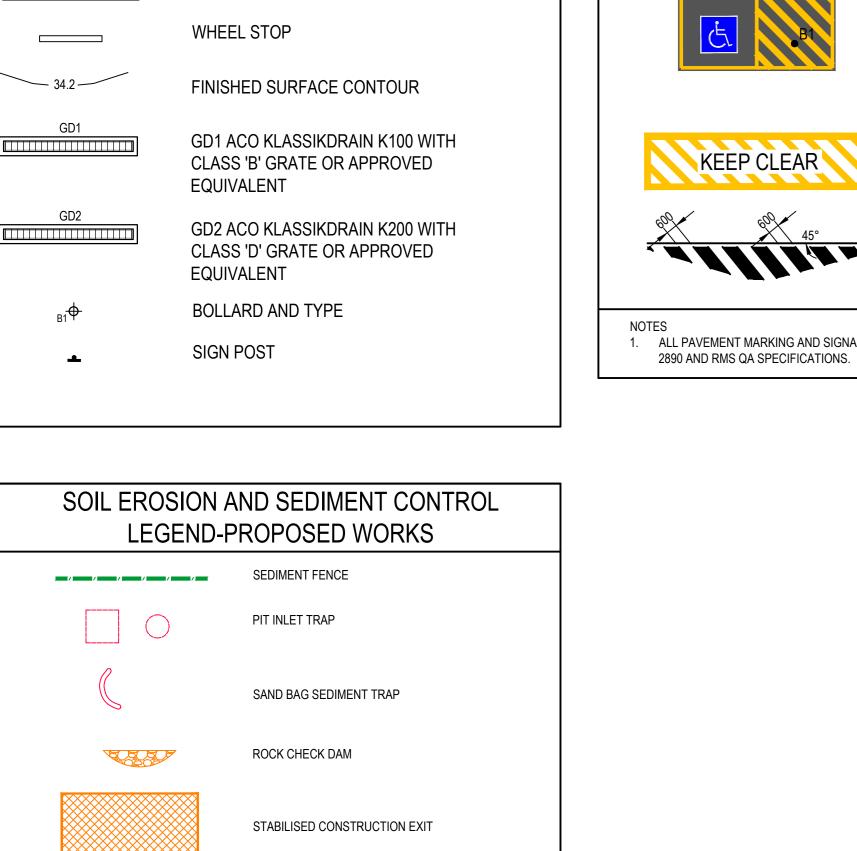


CUT OFF DRAIN

<sup>⊕</sup> |A0 | 150

STOCKPILE

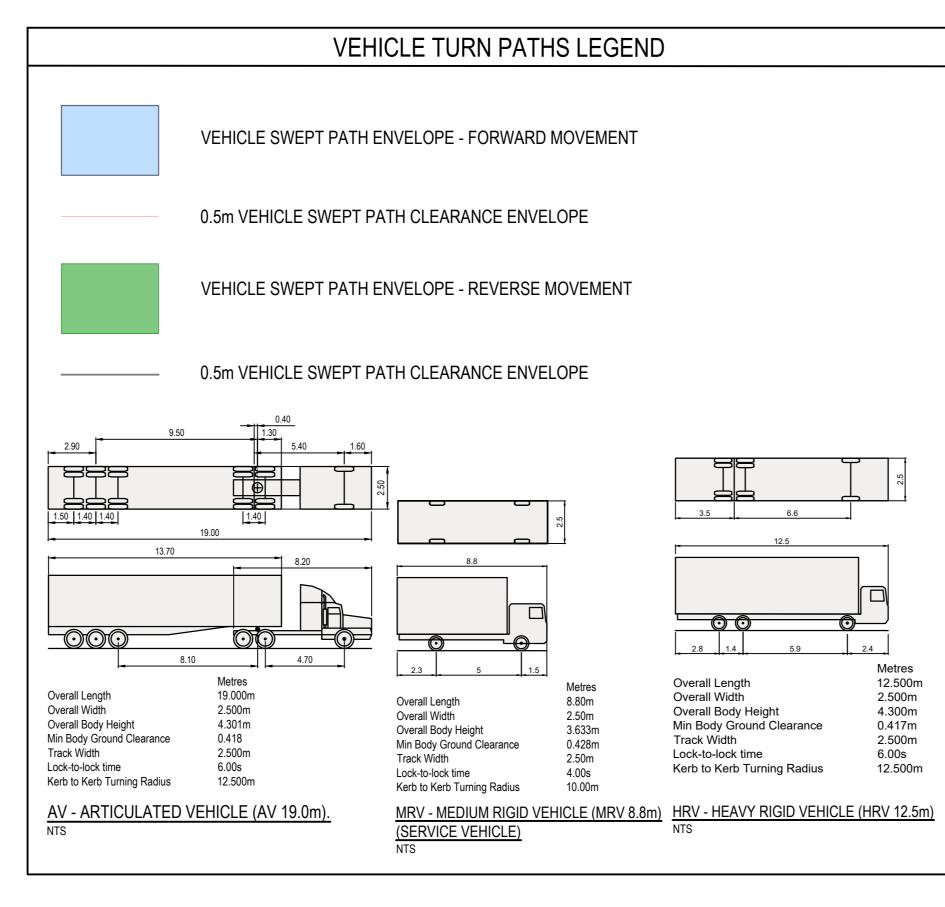




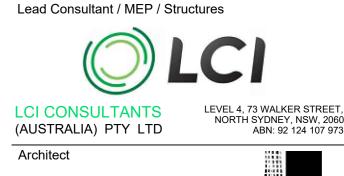







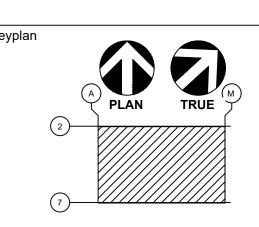

Project
SYD08 DATA CENTRE
57 STATION ROAD
SEVEN HILLS, NSW 2147
Drawing Title
LEGENDS SHEET

Drawing No.

Status ISSUE FOR SSDA
Scale @ A0
N/A

NSW202013\_C101.02

#### **GENERAL NOTES**

- THESE DRAWINGS SHALL BE READ IN CONJUNCTION WITH ALL ARCHITECTURAL AND STRUCTURAL CONSULTANTS DRAWINGS AND SPECIFICATIONS AND WITH SUCH OTHER WRITTEN INSTRUCTIONS AS MAY BE ISSUED.
- ALL WORKS SHALL BE UNDERTAKEN IN ACCORDANCE WITH THE BLACKTOWN CITY COUNCIL CIVIL WORKS SPECIFICATION (2005)
- ALL DIMENSIONS RELEVANT TO SETTING OUT AND OFF-SITE WORK SHALL BE VERIFIED BY THE CONTRACTOR BEFORE CONSTRUCTION
- 4. DIMENSIONS SHALL NOT BE OBTAINED BY SCALING THE DRAWINGS.
- 5. ALL DIMENSIONS ON DETAILS ARE IN MILLIMETRES UNLESS STATED OTHERWISE. ALL PLANS AND LEVELS ARE EXPRESSED IN METRES.
- DURING CONSTRUCTION THE CONTRACTOR SHALL BE RESPONSIBLE FOR MAINTAINING THE STRUCTURAL STABILITY OF THE WORKS AND ENSURE NO PARTS BE OVER STRESSED UNDER CONSTRUCTION ACTIVITIES.
- WORKMANSHIP AND MATERIALS ARE TO BE IN ACCORDANCE WITH THE RELEVANT CURRENT S.A.A. CODES INCLUDING ALL AMENDMENTS, AND THE LOCAL STATUTORY AUTHORITIES. EXCEPT WHERE VARIED BY THE CONTRACT DOCUMENTS.
- 8. THE APPROVAL OF A SUBSTITUTION SHALL BE SOUGHT FROM ACOR ENGINEER BUT IS NOT AN AUTHORISATION FOR A VARIATION. ANY VARIATIONS INVOLVED MUST BE TAKEN UP WITH ACOR CONSULTANTS / PRINCIPAL'S REPRESENTATIVE BEFORE THE WORK COMMENCES.
- ANY DISCREPANCIES OR OMISSIONS SHALL BE REFERRED TO THE ENGINEER FOR A DECISION BEFORE PROCEEDING WITH THE WORK.
- 10. THE CONTRACTOR SHALL GIVE 48 HOURS NOTICE FOR ALL ENGINEERING INSPECTIONS. ALL INSPECTIONS AND CERTIFICATIONS TO BE INCLUDED IN CONTRACTORS COST.
- 11. BUILDING FROM THESE DRAWINGS IS NOT TO COMMENCE UNTIL APPROVED BY THE PRINCIPAL CERTIFYING AUTHORITY.
- 12. THE WORD 'ENGINEER' USED IN THESE NOTES REFER TO AN EMPLOYEE OR NOMINATED REPRESENTATIVE OF **ACOR** CONSULTANTS PTY LTD.
- 13. ALL CONSTRUCTION ACTIVITIES SHALL COMPLY WITH THE RELEVANT CURRENT WORKPLACE HEALTH AND SAFETY LEGISLATION.

#### SITEWORKS NOTES

- 1. ORIGIN OF LEVELS :- AUSTRALIAN HEIGHT DATUM (A.H.D.)
- 2. CONTRACTOR MUST VERIFY ALL DIMENSIONS AND EXISTING LEVELS ON SITE PRIOR TO COMMENCEMENT OF WORK.
- ALL WORK IS TO BE UNDERTAKEN IN ACCORDANCE WITH THE DETAILS SHOWN ON THE DRAWINGS. THE SPECIFICATIONS AND THE DIRECTIONS OF THE PRINCIPAL'S REPRESENTATIVE.
- 4. EXISTING SERVICES HAVE BEEN PLOTTED FROM SUPPLIED DATA AND AS SUCH THEIR ACCURACY CANNOT BE GUARANTEED. IT IS THE RESPONSIBILITY OF THE CONTRACTOR TO ESTABLISH THE LOCATION AND LEVEL OF ALL EXISTING SERVICES PRIOR TO THE COMMENCEMENT OF ANY WORK. ANY DISCREPANCIES SHALL BE REPORTED TO THE PRINCIPAL'S REPRESENTATIVE. CLEARANCES SHALL BE OBTAINED FROM THE RELEVANT SERVICE AUTHORITY.
- WHERE NEW WORKS ABUT EXISTING THE CONTRACTOR SHALL ENSURE THAT A SMOOTH EVEN PROFILE, FREE FROM ABRUPT CHANGES IS OBTAINED.
- THE CONTRACTOR SHALL ARRANGE ALL SURVEY SETOUT TO BE CARRIED OUT BY A REGISTERED SURVEYOR.
- CARE IS TO BE TAKEN WHEN EXCAVATING NEAR EXISTING SERVICES. NO MECHANICAL EXCAVATIONS ARE TO BE UNDERTAKEN OVER COMMUNICATIONS OR ELECTRICAL SERVICES. HAND EXCAVATE IN THESE AREAS.
- 8. ALL SERVICE TRENCHES UNDER VEHICULAR PAVEMENTS SHALL BE BACKFILLED WITH AN APPROVED NON-NATURAL GRANULAR MATERIAL AND COMPACTED TO 98% STANDARD MAXIMUM DRY DENSITY IN ACCORDANCE WITH AS.1289.5.1.1.
- 9. ALL TRENCH BACKFILL MATERIAL SHALL BE COMPACTED TO THE SAME DENSITY AS THE ADJACENT MATERIAL.
- 10. ON COMPLETION OF PIPE INSTALLATION ALL DISTURBED AREAS MUST BE RESTORED TO ORIGINAL, INCLUDING KERBS. FOOTPATHS, CONCRETE AREAS, GRAVEL AND GRASSED AREAS AND ROAD PAVEMENTS.
- 11. PROVIDE 10mm WIDE EXPANDING CORK JOINTS BETWEEN CONCRETE PAVEMENTS AND ALL BUILDINGS, WALLS, FOOTINGS, COLUMNS, KERBS, DISH DRAINS, GRATED DRAINS, BOLLARD FOOTINGS ETC
- 12. CONTRACTOR TO OBTAIN ALL AUTHORITY APPROVALS.
- 13. ALL BATTERS TO BE GRASSED LINED WITH MINIMUM 100 TOPSOIL AND APPROVED COUCH LAID AS TURF.
- 14. MAKE SMOOTH TRANSITION TO EXISTING SERVICES AND MAKE GOOD.
- 15. THE CONTRACTOR SHALL PROVIDE ALL TEMPORARY DIVERSION DRAINS AND MOUNDS TO ENSURE THAT AT ALL TIMES EXPOSED SURFACES ARE FREE DRAINING AND WHERE NECESSARY EXCAVATE SUMPS AND PROVIDE PUMPING EQUIPMENT TO DRAIN EXPOSED AREAS.
- 16. ON COMPLETION OF WORKS ALL DISTURBED AREAS MUST BE RESTORED TO ORIGINAL INCLUDING. BUT NOT LIMITED TO. KERBS, FOOTPATHS, CONCRETE AREAS, GRASS AND LANDSCAPED AREAS.

<sup>≅</sup> |A0 | 150

#### EXISTING SERVICES AND FEATURES

- 1. THE CONTRACTOR SHALL ALLOW FOR THE CAPPING OFF, EXCAVATION, REMOVAL AND DISPOSAL IF REQUIRED OF ALL EXISTING SERVICES IN AREAS AFFECTED BY WORKS WITHIN THE CONTRACT AREA, AS SHOWN ON THE DRAWINGS UNLESS DIRECTED OTHERWISE BY THE SUPERINTENDENT.
- 2. THE CONTRACTOR SHALL ENSURE THAT AT ALL TIMES SERVICES TO ALL BUILDINGS NOT AFFECTED BY THE WORKS ARE NOT DISRUPTED.
- PRIOR TO COMMENCEMENT OF ANY WORKS THE CONTRACTOR SHALL GAIN WRITTEN APPROVAL OF HIS PROGRAMME FOR THE RELOCATION/CONSTRUCTION OF TEMPORARY SERVICES.
- 4. EXISTING BUILDINGS, EXTERNAL STRUCTURES, AND TREES SHOWN ON THESE DRAWINGS ARE FEATURES EXISTING PRIOR TO ANY DEMOLITION WORKS.
- CONTRACTOR SHALL CONSTRUCT TEMPORARY SERVICES TO MAINTAIN EXISTING SUPPLY TO BUILDINGS REMAINING IN OPERATION DURING WORKS TO THE SATISFACTION AND APPROVAL OF THE SUPERINTENDENT. ONCE DIVERSION IS IS COMPLETE AND COMMISSIONED THE CONTRACTOR SHALL REMOVE ALL SUCH TEMPORARY SERVICES AND MAKE GOOD TO THE SATISFACTION OF THE SUPERINTENDENT.
- 6. INTERRUPTION TO SUPPLY OF EXISTING SERVICES SHALL BE DONE SO AS NOT TO CAUSE ANY INCONVENIENCE TO THE PRINCIPAL, CONTRACTOR TO GAIN APPROVAL OF SUPERINTENDENT FOR TIME OF INTERRUPTION.

#### **COMPACTION NOTES**

- REFER TO GEOTECHNICAL INVESTIGATION REPORT PREPARED BY MARTENS CONSULTING ENGINEERS, REF: P2007944JR05V03 DATED: FEBRUARY 2022
- 2. STRIP TOPSOIL TO EXPOSE NATURALLY OCCURRING MATERIAL AND STOCKPILE ON SITE FOR SELECTIVE RE-USE OR DISPOSE OFF-SITE AS DIRECTED BY THE SUPERINTENDENT. DEPTH OF TOPSOIL TO BE STRIPPED SHOWN ON THE BULK EARTHWORKS PLANS IS INDICATIVE ONLY BASED ON AVAILABLE GEOTECHNICAL INFORMATION. IT IS THE CONTRACTOR'S RESPONSIBILITY TO ALLOW TO STRIP TOPSOIL TO THE APPROPRIATE DEPTH TO EXPOSE THE UNDERLYING NATURALLY OCCURRING MATERIAL.
- 3. UNCONTROLLED FILLING IS TO BE REMOVED FROM THE FOOTPRINT OF THE BUILDING AND PAVEMENT AREAS. THE STRIPPED SURFACE SHALL BE INSPECTED BY A GEOTECHNICAL ENGINEER.
- 4. PROOF ROLL EXPOSED NATURAL SURFACE WITH A MINIMUM OF EIGHT PASSES OF A SMOOTH DRUM ROLLER (MINIMUM STATIC WEIGHT OF 10 TONNES) THE FINAL PASS SHALL BE IN THE PRESENCE OF A GEOTECHNICAL ENGINEER.
- 5. ALL SOFT. WET OR UNSUITABLE MATERIAL TO BE REMOVED AS DIRECTED BY THE GEOTECHNICAL ENGINEER AND REPLACED WITH APPROVED MATERIAL SATISFYING THE REQUIREMENTS LISTED BELOW.
- 6. WASTE CLASSIFICATION OF SPOIL MATERIAL, INCLUDING PROVISION OF APPROPRIATE HAZARDOUS MATERIALS HANDLING (AS REQUIRED) IS THE RESPONSIBILITY OF THE CONTRACTOR PRIOR TO UNDERTAKING THE EXCAVATION WORKS.
- 7. ALL FILL MATERIAL SHALL BE FROM A SOURCE APPROVED BY THE GEOTECHNICAL ENGINEER AND SHALL COMPLY WITH THE FOLLOWING:
  - a. FREE FROM ORGANIC, PERISHABLE AND CONTAMINATED MATTER
  - b. MAXIMUM PARTICLE SIZE 75MM c. PLASTICITY INDEX BETWEEN 2% AND 15%
- 8. ALL FILL MATERIAL SHALL BE PLACED IN MAXIMUM 300MM THICK LAYERS AND COMPACTED AT OPTIMUM MOISTURE CONTENT (+ OR - 2%) TO ACHIEVE A DRY DENSITY DETERMINED IN ACCORDANCE WITH AS 1289 5.3.1 OF NOT LESS THAN THE FOLLOWING STANDARD MAXIMUM DRY DENSITY IN ACCORDANCE WITH AS 1289 E5.1.1:

LOCATION	STANDARD DRY
DENSITY	
UNDER BUILDING SLABS	98%
AREAS OF SERVICE TRENCHES	98%
EXTERNAL PAVED AREAS, ROADS	AND CARPARKS 98%
LANDSCAPED AREAS	90%

THE UPPER 0.5m THICKNESS FOR THE FOLLOWING AREAS MUST BE COMPACTED AT OPTIMUM MOISTURE CONTENT (+ OR -2%) AS FOLLOWS

LOCATION	STANDARD DRY
DENSITY	STANDARD DRT
UNDER BUILDING SLABS	100
PAVEMENTS AND CARPARKS	100

- 9. THE CONTRACTOR SHALL PROGRAM THE EARTHWORKS OPERATION SO THAT THE WORKING AREAS ARE ADEQUATELY DRAINED DURING THE PERIOD OF CONSTRUCTION. THE SURFACE SHALL BE GRADED AND SEALED OFF TO REMOVE DEPRESSIONS, ROLLER MARKS AND SIMILAR WHICH WOULD ALLOW WATER TO POND AND PENETRATE THE UNDERLYING MATERIAL. ANY DAMAGE RESULTING FROM THE CONTRACTOR NOT OBSERVING THESE REQUIREMENTS SHALL BE RECTIFIED BY THE CONTRACTOR AT THEIR COST.
- 10. TESTING OF THE SUBGRADE SHALL BE CARRIED OUT BY AN APPROVED NATA REGISTERED LABORATORY AT THE CONTRACTORS EXPENSE. TESTING FREQUENCY SHALL BE IN ACCORDANCE WITH THE FREQUENCY SPECIFIED IN AS1289
- 11. DO NOT CARRY OUT BACKFILLING UNTIL AT LEAST 100% OF THE SPECIFIED MINIMUM 28 DAY CONCRETE COMPRESSIVE STRENGTH OF THE STRUCTURE HAS BEEN ACHIEVED, BUT IN ANY CASE NOT EARLIER THAN 7 DAYS AFTER CONCRETE PLACEMENT
- 12. DO NOT USE VIBRATING ROLLERS OF MASS EXCEEDING ONE TONNE. OR ANY OTHER EQUIPMENT THAT MAY POTENTIALLY CAUSE DAMAGE TO EARTH RETAINING STRUCTURES. TO COMPACT FILL MATERIAL LOCATED WITHIN 2m BEHIND THE STRUCTURE.

#### EROSION AND SEDIMENT CONTROL NOTES

#### GENERAL INSTRUCTIONS

- E1. THIS PLAN IS TO BE READ IN CONJUNCTION WITH THE ENGINEERING PLANS. AND ANY OTHER PLANS OR WRITTEN INSTRUCTIONS THAT MAY BE ISSUED AND RELATING TO DEVELOPMENT AT THE SUBJECT SITE
- E2. THE PRINCIPAL'S REPRESENTATIVE WILL ENSURE THAT ALL SOIL AND WATER MANAGEMENT WORKS ARE UNDERTAKEN AS INSTRUCTED IN THIS SPECIFICATION AND CONSTRUCTED FOLLOWING THE GUIDELINES OF "MANAGING URBAN STORMWATER SOILS AND CONSTRUCTION". DEPT OF HOUSING, 2004 (BLUE BOOK).
- E3. ALL BUILDERS AND SUB-CONTRACTORS WILL BE INFORMED OF THEIR RESPONSIBILITIES IN MINIMISING THE POTENTIAL FOR SOIL EROSION AND POLLUTION TO DOWNSLOPE LANDS AND WATERWAYS.

#### CONSTRUCTION SEQUENCE

- E4. THE SOIL EROSION POTENTIAL ON THIS SITE SHALL BE MINIMISED. HENCE WORKS SHALL BE UNDERTAKEN IN THE FOLLOWING SEQUENCE:
- a. INSTALL SEDIMENT FENCES, TEMPORARY CONSTRUCTION EXIT AND SANDBAG KERB INLET SEDIMENT TRAP.
- b. UNDERTAKE SITE DEVELOPMENT WORKS IN ACCORDANCE WITH ENGINEERING PLANS. PHASE DEVELOPMENT SO THAT LAND DISTURBANCE IS CONFINED TO AREAS OF WORKABLE SIZE.

#### **EROSION CONTROL**

- E5. DURING WINDY CONDITIONS, LARGE, UNPROTECTED AREAS WILL BE KEPT MOIST (NOT WET) BY SPRINKLING WITH WATER TO KEEP DUST UNDER CONTROL.
- E6. FINAL SITE LANDSCAPING WILL BE UNDERTAKEN AS SOON AS POSSIBLE AND WITHIN 20 WORKING DAYS FROM COMPLETION OF CONSTRUCTION ACTIVITIES.

#### **FENCING**

- E7. STOCKPILES WILL NOT BE LOCATED WITHIN 2 METRES OF HAZARD AREAS, INCLUDING LIKELY AREAS OF CONCENTRATED OR HIGH VELOCITY FLOWS SUCH AS WATERWAYS. WHERE THEY ARE BETWEEN 2 AND 5 METRES FROM SUCH AREAS, SPECIAL SEDIMENT CONTROL MEASURES SHOULD BE TAKEN TO MINIMISE POSSIBLE POLLUTION TO DOWNSLOPE WATERS, E.G. THROUGH INSTALLATION OF SEDIMENT FENCING.
- E8. ANY SAND USED IN THE CONCRETE CURING PROCESS (SPREAD OVER THE SURFACE) WILL BE REMOVED AS SOON AS POSSIBLE AND WITHIN 10 WORKING DAYS FROM PLACEMENT.
- E9. WATER WILL BE PREVENTED FROM ENTERING THE PERMANENT DRAINAGE SYSTEM UNLESS IT IS RELATIVELY SEDIMENT FREE, I.E. THE CATCHMENT AREA HAS BEEN PERMANENTLY LANDSCAPED AND/OR ANY LIKELY SEDIMENT HAS BEEN FILTERED THROUGH AN APPROVED STRUCTURE.
- E10. TEMPORARY SOIL AND WATER MANAGEMENT STRUCTURES WILL BE REMOVED ONLY AFTER THE LANDS THEY ARE PROTECTING ARE REHABILITATED.

#### OTHER MATTERS

- E11. ACCEPTABLE RECEPTORS WILL BE PROVIDED FOR CONCRETE AND MORTAR SLURRIES, PAINTS, ACID WASHINGS, LIGHT-WEIGHT WASTE MATERIALS AND LITTER.
- E12. RECEPTORS FOR CONCRETE AND MORTAR SLURRIES, PAINTS. ACID WASHINGS. LIGHT-WEIGHT WASTE MATERIALS AND LITTER ARE TO BE EMPTIED AS NECESSARY. DISPOSAL OF WASTE SHALL BE IN A MANNER APPROVED BY THE PRINCIPAL'S REPRESENTATIVE.

#### SITE INSPECTION & MAINTENANCE

E13. EROSION AND SEDIMENT CONTROL MEASURES SHALL BE INSPECTED AFTER RAINFALL EVENTS TO ENSURE THAT THEY OPERATE EFFECTIVELY. REPAIR AND OR MAINTENANCE SHALL BE UNDERTAKEN AS REQUIRED.

#### STORMWATER NOTES

ENSURE A SMOOTH FINISH.

- 1. ALL 225 DIA. DRAINAGE PIPES AND LARGER SHALL BE CLASS "2" APPROVED SPIGOT AND SOCKET FRC OR RCP PIPES WITH RUBBER RING JOINTS. (U.N.O.)
- 2. ALL PIPE JUNCTIONS UP TO AND INCLUDING 450 DIA. AND TAPERS SHALL BE VIA PURPOSE MADE FITTINGS.
- CONTRACTOR TO SUPPLY AND INSTALL ALL FITTINGS AND SPECIALS INCLUDING VARIOUS PIPE ADAPTORS TO ENSURE PROPER CONNECTION BETWEEN DISSIMILAR PIPEWORK.
- 4. ALL CONNECTIONS TO EXISTING DRAINAGE PITS SHALL BE MADE IN A TRADESMAN-LIKE MANNER AND THE INTERNAL WALL OF THE PIT AT THE POINT OF ENTRY SHALL BE CEMENT RENDERED TO
- PRECAST PITS SHALL NOT BE USED UNLESS WRITTEN APPROVAL IS OBTAINED FROM THE ENGINEER.
- 6. WHERE TRENCHES ARE IN ROCK, THE PIPE SHALL BE BEDDED ON A MIN. 50MM CONCRETE BED (OR 75MM THICK BED OF 12MM BLUE METAL) UNDER THE BARREL OF THE PIPE. THE PIPE COLLAR AT NO POINT SHALL BEAR ON THE ROCK. IN OTHER THAN ROCK. PIPES SHALL BE LAID ON A 75MM THICK SAND BED. IN ALL CASES BACKFILL THE TRENCH WITH SAND TO 200MM ABOVE THE PIPE. WHERE THE PIPE IS UNDER PAVEMENTS BACKFILL REMAINDER OF TRENCH WITH SAND OR APPROVED GRANULAR BACKFILL COMPACTED IN 150MM LAYERS TO 98% STANDARD MAX. DRY DENSITY.
- BEDDING SHALL BE (U.N.O.) TYPE HS2, IN ACCORDANCE WITH CURRENT RELEVANT AUSTRALIAN STANDARDS.
- 8. WHERE STORMWATER LINES PASS UNDER FLOOR SLABS SEWER GRADE RUBBER RING JOINTS ARE TO BE USED.
- 9. WHERE SUBSOIL DRAINAGE LINES PASS UNDER FLOOR SLABS AND VEHICULAR PAVEMENTS UNSLOTTED UPVC SEWER GRADE PIPE SHALL BE USED.
- 10. PROVIDE 3.0M LENGTH OF 100 DIA. SUBSOIL DRAINAGE PIPE WRAPPED IN FABRIC SOCK, AT UPSTREAM END OF EACH PIT

B ISSUE FOR SSDA A ISSUE FOR SSDA 14.03.22 RG MB No. Description Date By Chk

22.03.22 RG MB


Lead Consultant / MEP / Structures

(AUSTRALIA) PTY LTD







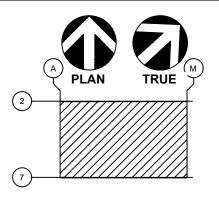


SYD08 DATA CENTRE 57 STATION ROAD SEVEN HILLS, NSW 2147 Drawing Title

NOTES

ISSUE FOR SSDA Scale @ A0

NSW202013

Drawing No. NSW202013\_C101.03

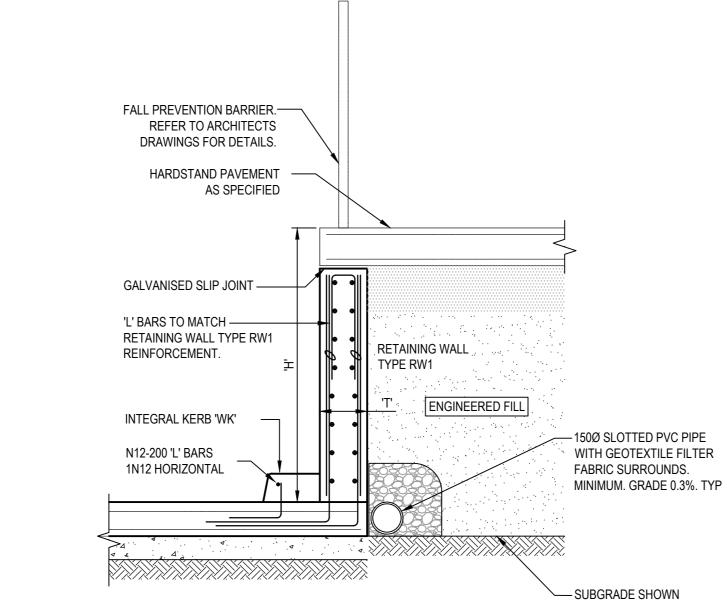


TYPICAL LOADING DOCK RETAINING WALL DETAIL
SCALE 1:20


4. ALL EXPOSED FACES OF CONCRETE RETAINING WALLS TO HAVE CLASS 2 SURFACE FINISH IN ACCORDANCE WITH AS 3610 U.N.O.


RETAINING WALL BASE TO BE FOUNDED ON GROUND WITH ALLOWABLE BEARING CAPACITY OF 150kPa OR BETTER T.B.C BY GEOTECHNICAL ENGINEER. WHERE ALLOWABLE BEARING IS INSUFFICIENT, FOOTINGS SHALL BE EXCAVATED UNTIL THE REQUIRED FOUNDING MATERIAL IS REACHED AND CONFIRMED BY GEOTECHNICAL ENGINEER. OVER-EXCAVATION SHALL BE BACKFILLED WITH N15 CONCRETE. 3. EXCAVATION OF BACKFILL FOR SERVICES INSTALLATION MUST BE REINSTATED TO REQUIREMENTS OF THE BACKFILL SPECIFICATION.

RETAINING WALL SCHEDULE								
TYPE	WALL HEIGHT	MIN. WALL THICKNESS	BASE WIDTH	MIN. BASE DEPTH	REINFORCEMENT	COMMENT		
	'H'	'T'	'L'	'D1'	'V' BARS			
RW1	0 - 1300	300	1500	300	N16-200 EACH FACE	INTERNAL RETAINING WALL - 12kPA SURCHARGE		

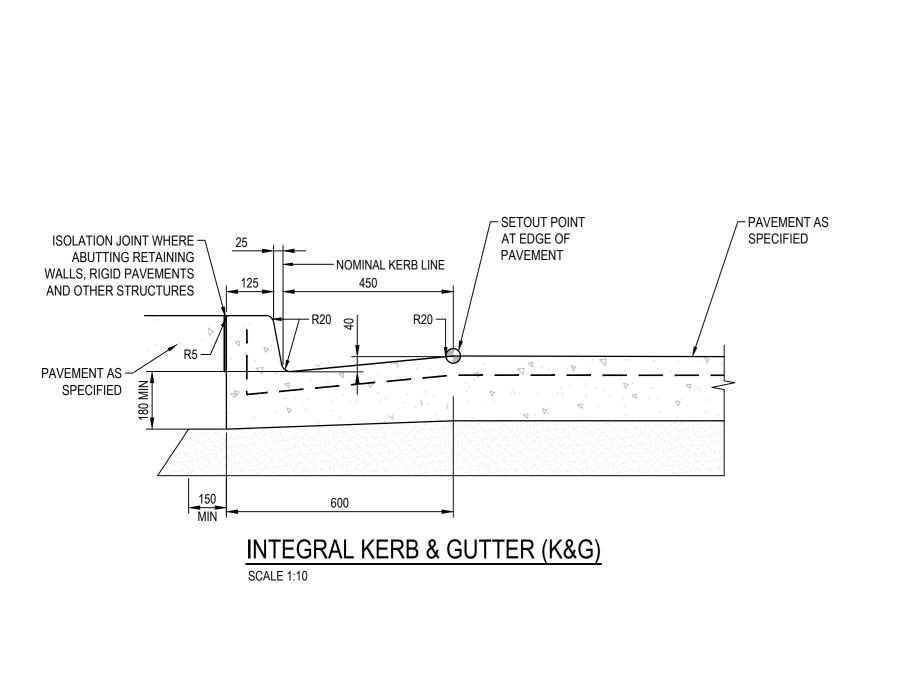


<sup>≝</sup> |A0

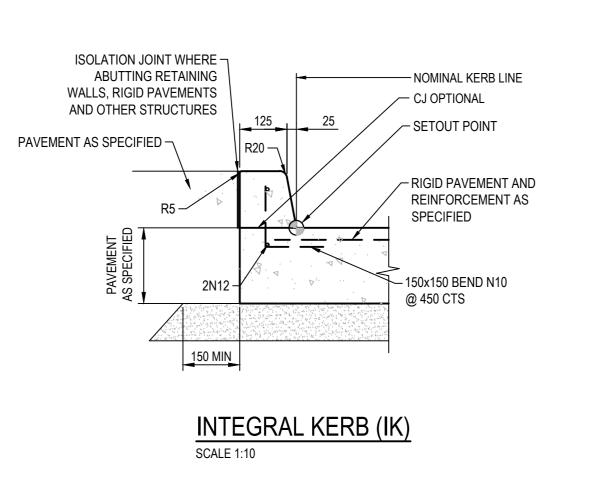


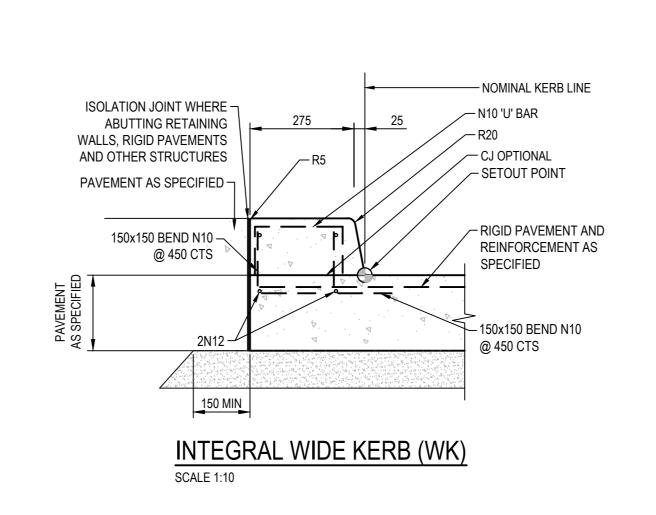



INDICATIVELY ONLY

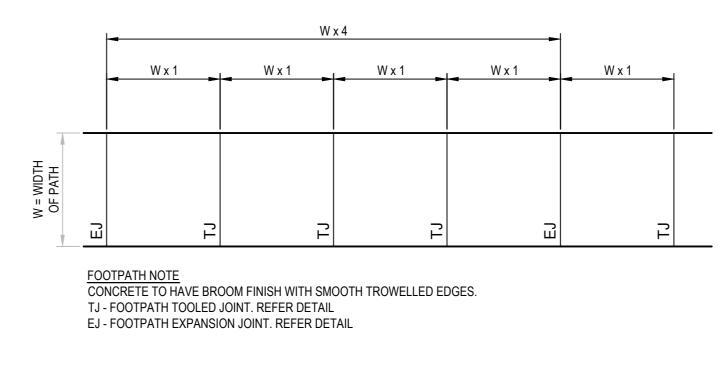


## TYPICAL JOINT PLAN FOR FOOTPATHS

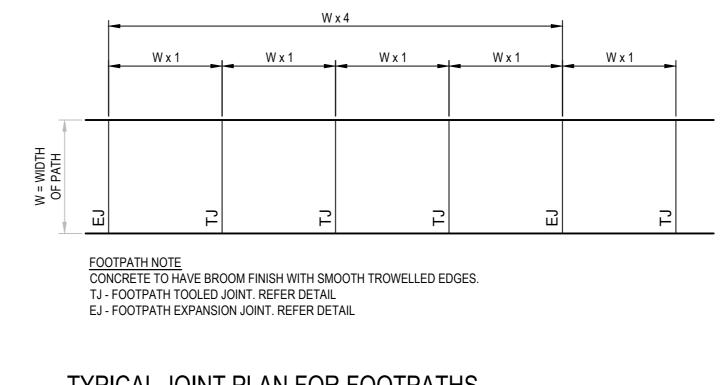

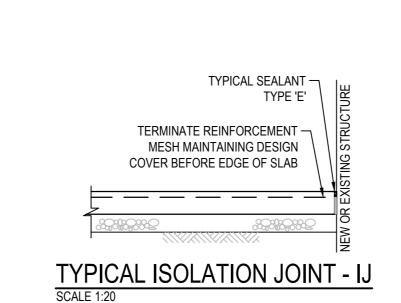


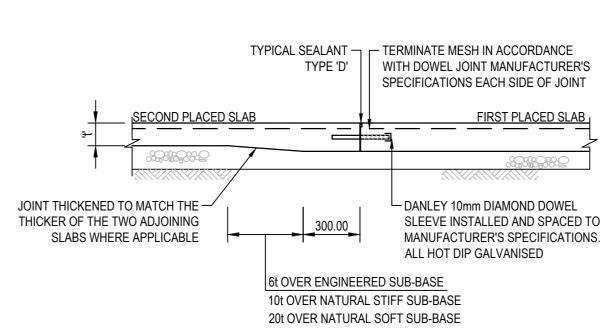

# TYPICAL DIAMOND DOWEL JOINT - DDJ

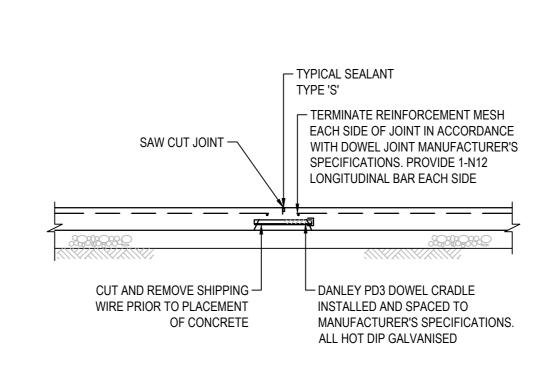

# TYPICAL CONTINUOUS POUR DOWEL JOINT - CDJ SCALE 1:20

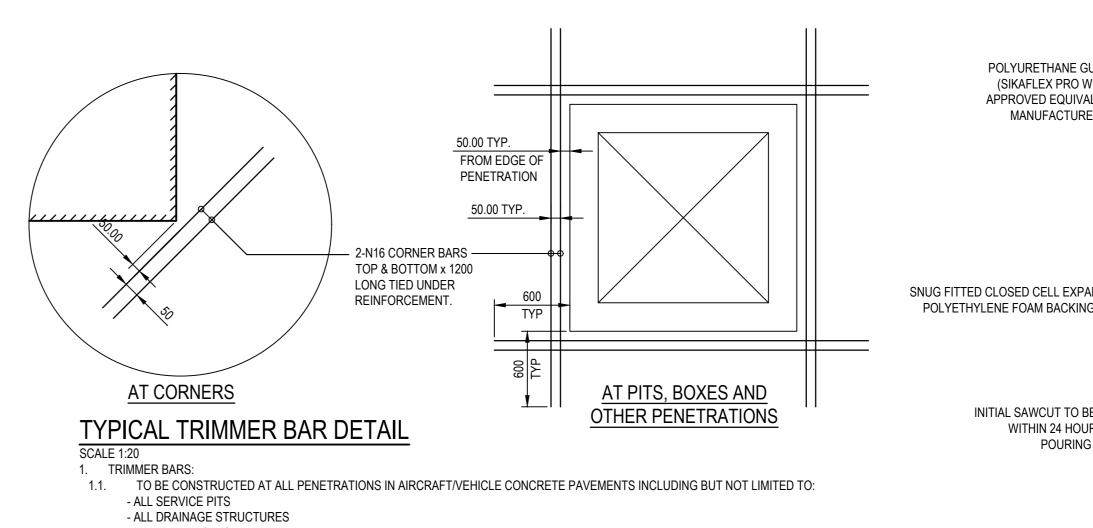

- ALL VALVE BOXES - ALL IN-GROUND FIRE HYDRANTS - ALL PROTRUDING CORNERS OF STRUCTURES OR SLABS - ALL COLUMNS PENETRATING CONCRETE PAVEMENT


2. CONSTRUCT 2-N16 TRIMMER BARS (1200LONG, TOP AND BOTTOM) AT ALL MISMATCHED OR DISCONTINUOUS JOINTS. TYPICAL

TYPICAL SEALANT TYPE 'E' \_ \_ TERMINATE REINFORCEMENT MESH MAINTAINING DESIGN COVER EACH SIDE OF JOINT TYPICAL FOOTPATH EXPANSION JOINT - EJ


> 30 x 3 TOOLED JOINT \_ \_ MAINTAIN REINFORCEMENT COVER IN ACCORDANCE WITH SITE EXPOSURE LEVEL.

TYPICAL FOOTPATH TOOLED JOINT -TJ


SCALE 1:20

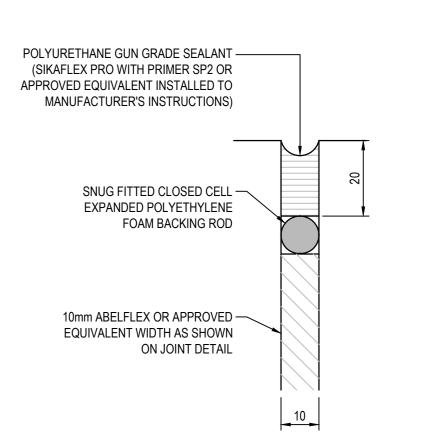

TYPICAL JOINT SEALANT TYPE 'E'

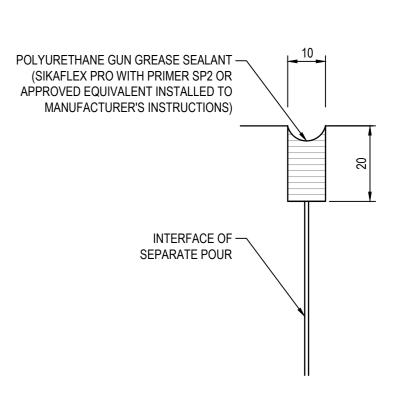

TYPICAL JOINT SEALANT TYPE 'D' SCALE 1:1

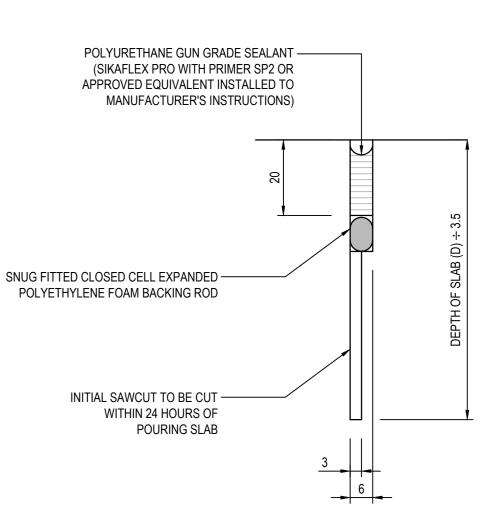

TYPICAL JOINT SEALANT TYPE 'S'


22.03.22 RG MB B ISSUE FOR SSDA 14.03.22 RG MB A ISSUE FOR SSDA Date By Chk No. Description

Lead Consultant / MEP / Structures LEVEL 4, 73 WALKER STREET, NORTH SYDNEY, NSW, 2060 ABN: 92 124 107 973 (AUSTRALIA) PTY LTD Architect

p:po box 5036 west chatswood nsw 1515 t: (02) 8966 6000  $\operatorname{dem}$ w:www.dem.com.au





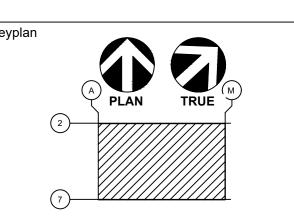


SYD08 DATA CENTRE **57 STATION ROAD** SEVEN HILLS, NSW 2147 Drawing Title DETAILS SHEET 1


ISSUE FOR SSDA AS SHOWN


NSW202013\_C101.05

Drawing No.

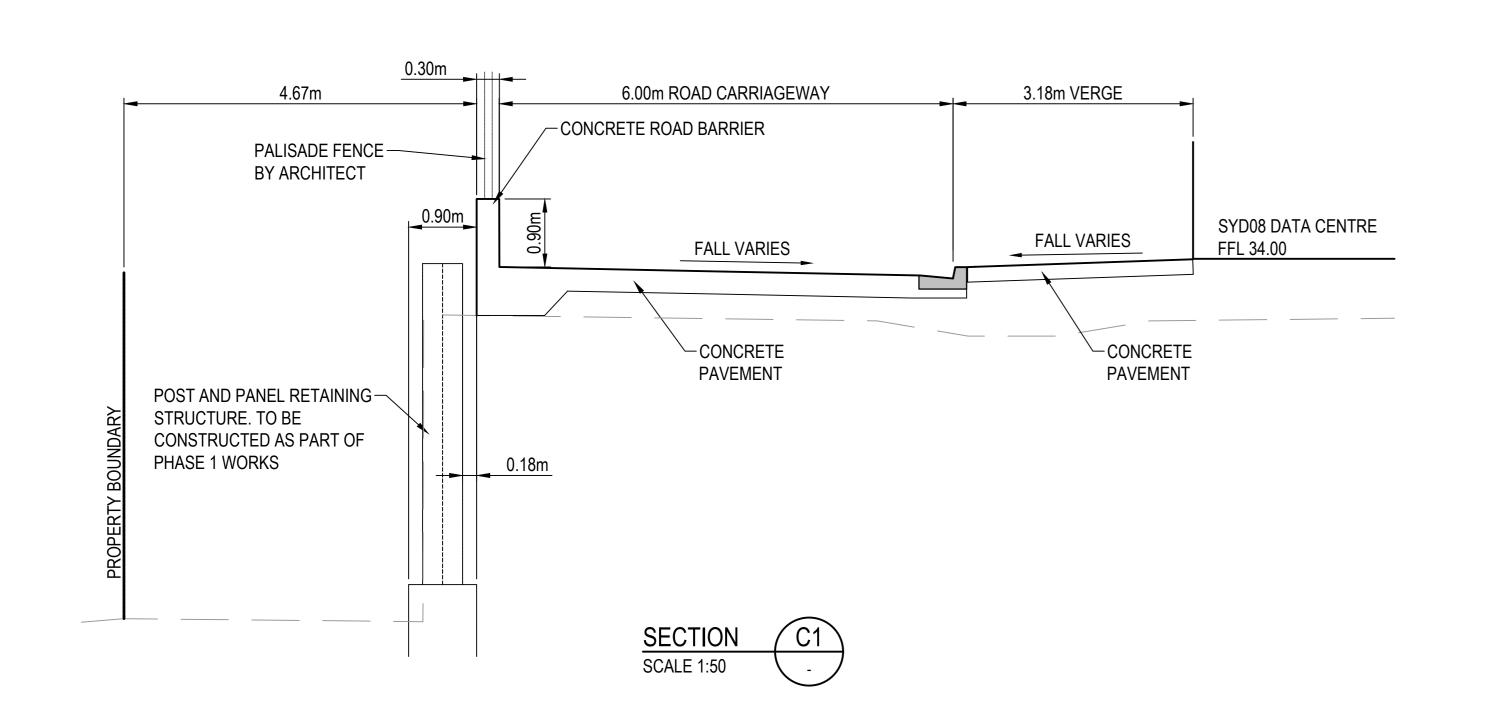

<sup>⊕</sup> |A0

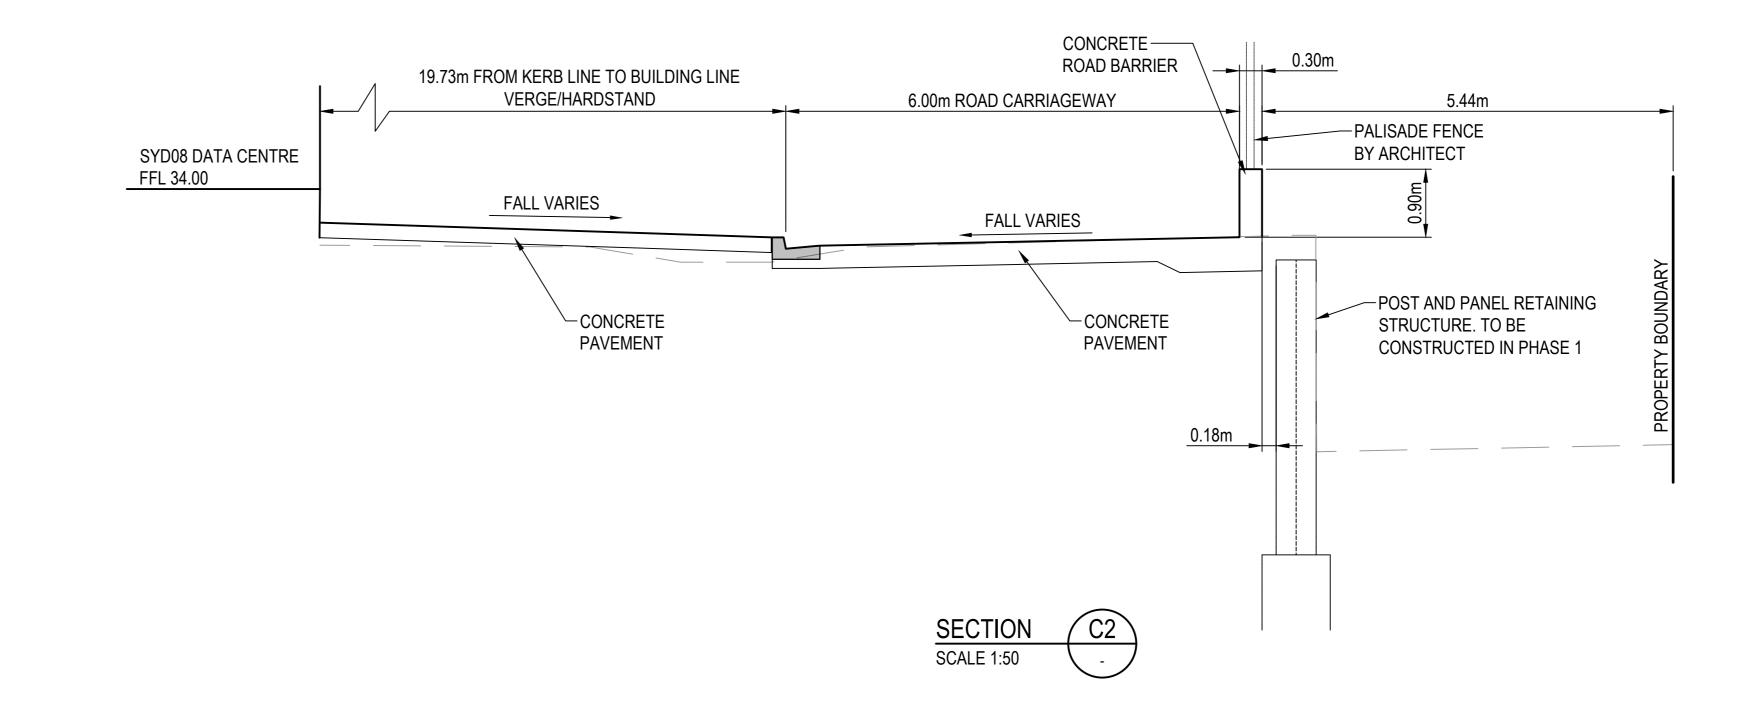

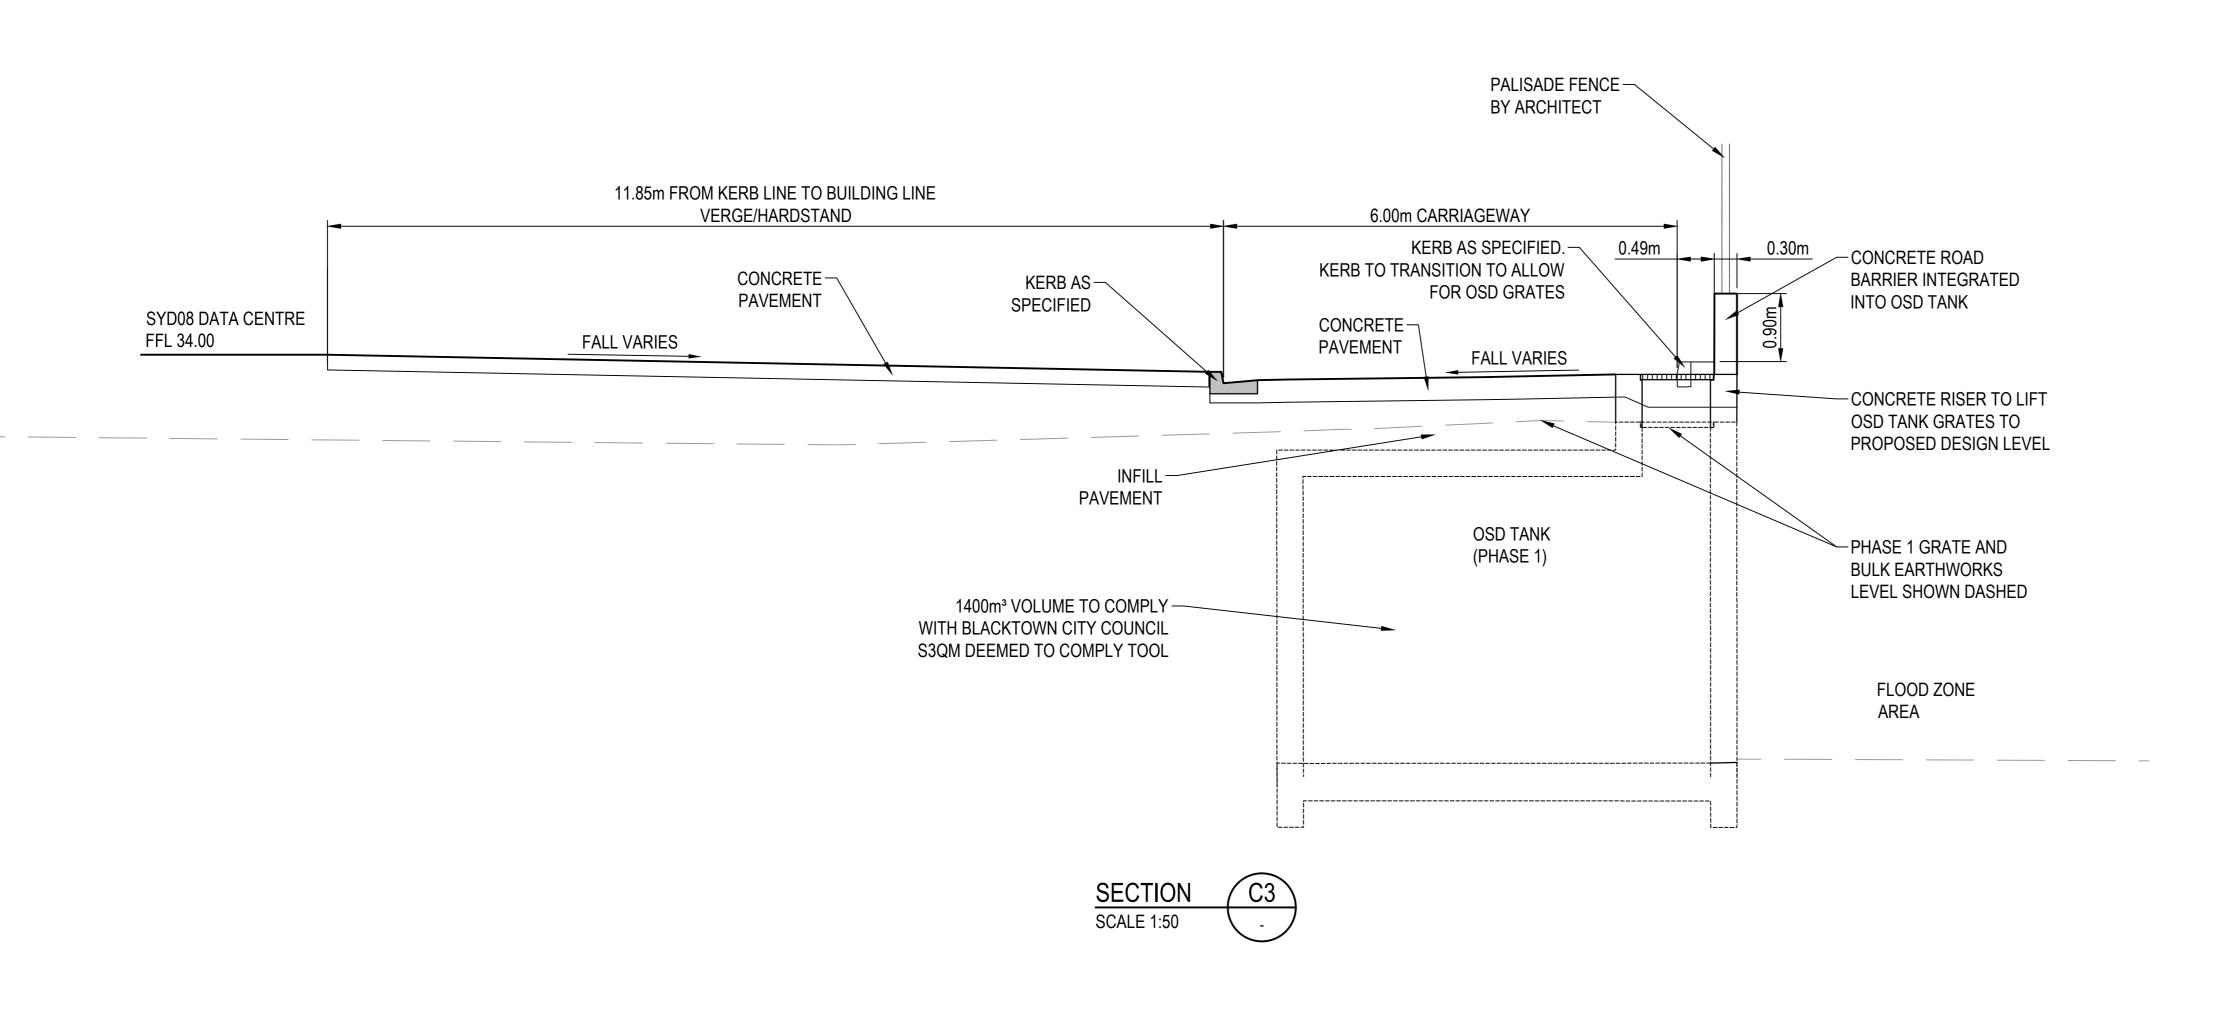

B ISSUE FOR SSDA 22.03.22 RG MB 14.03.22 RG MB A ISSUE FOR SSDA Date By Chk No. Description


Lead Consultant / MEP / Structures

LCI CONSULTANTS (AUSTRALIA) PTY LTD LEVEL 4, 73 WALKER STREET, NORTH SYDNEY, NSW, 2060 ABN: 92 124 107 973

p: po box 5036 west chatswood nsw 1515 t: (02) 8966 6000 w:www.dem.com.au  $\operatorname{dem}$ 

CONSULTANTS



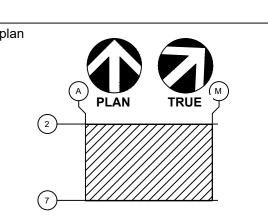


Project
SYD08 DATA CENTRE 57 STATION ROAD SEVEN HILLS, NSW 2147

Drawing Title
DETAILS
SHEET 2

ISSUE FOR SSDA


NSW202013\_C101.06

#### SANDBAG SEDIMENT TRAP - AT KERB SAG PIT

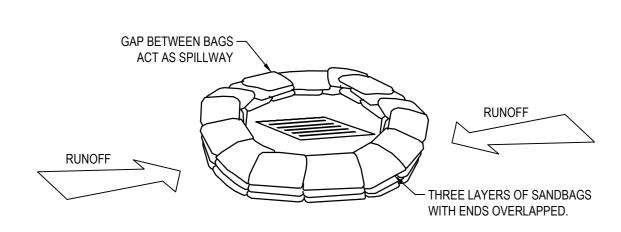

SANDBAG SEDIMENT TRAP - AT OTHER THAN KERB SAG PIT

### SANDBAG SEDIMENT TRAP DETAILS

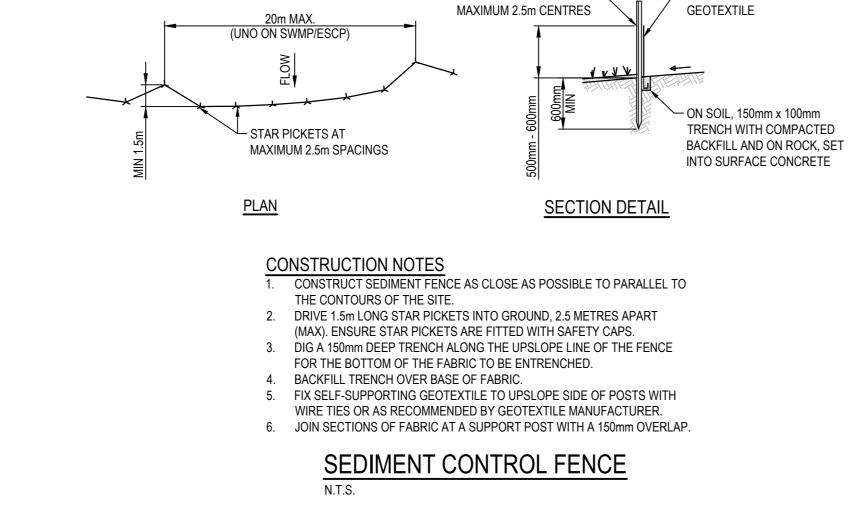

DISTURBED AREA

UNDISTURBED AREA


OF FLOW

1.5m STAR PICKETS AT

MAXIMUM 2.5m CENTRES

1.5m STAR PICKETS AT —

/- SELF-SUPPORTING

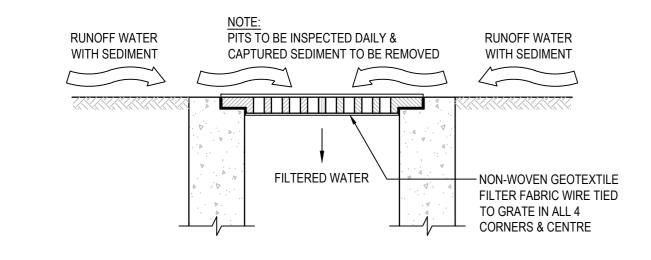


INLET TRAP

N.T.S.

NOTE

TO BE USED IN PAVED AREAS WHERE TRAFFIC ACCESS IS REQUIRED

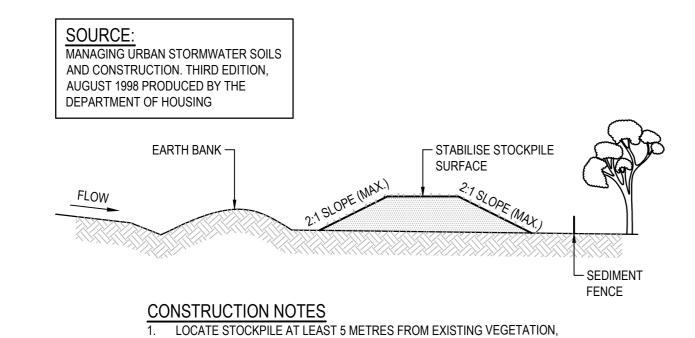



CONCENTRATED WATER FLOWS, ROADS AND HAZARD AREAS.
CONSTRUCT ON THE CONTOUR AS A LOW, FLAT, ELONGATED MOUND.
WHERE THERE IS SUFFICIENT AREA TOPSOIL STOCKPILES SHALL BE LESS THAN 2 METERS IN HEIGHT.
REHABILITATE IN ACCORDANCE WITH THE SWMP/ESCP.
CONSTRUCT EARTH BANK (STANDARD DRAWING 5-2) ON THE UPSLOPE SIDE TO DIVERT RUN OFF AROUND THE STOCKPILE AND A SEDIMENT FENCE (STANDARD

STOCKPILES N.T.S.

DRAWING 6-7) 1 TO 2 METRES DOWNSLOPE OF STOCKPILE.

<sup>⊕</sup> |A0

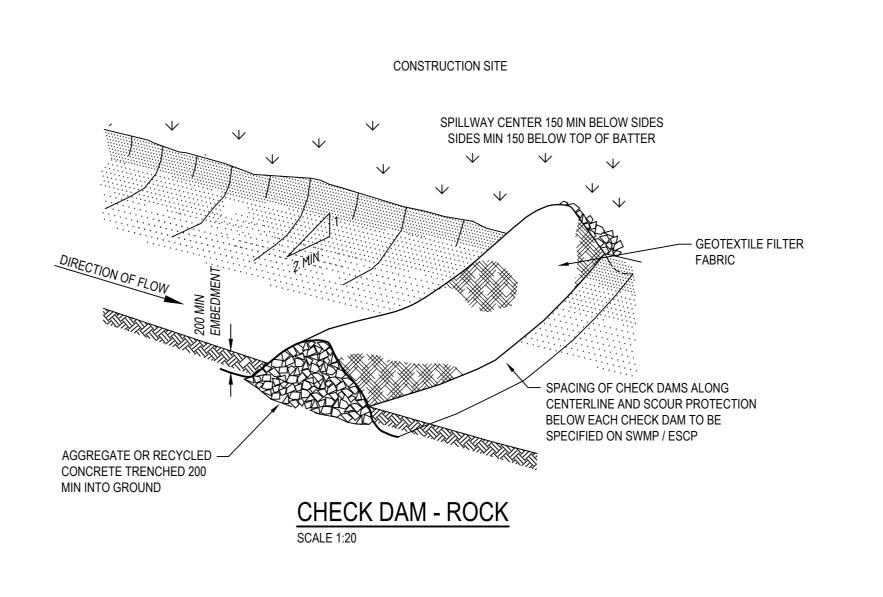

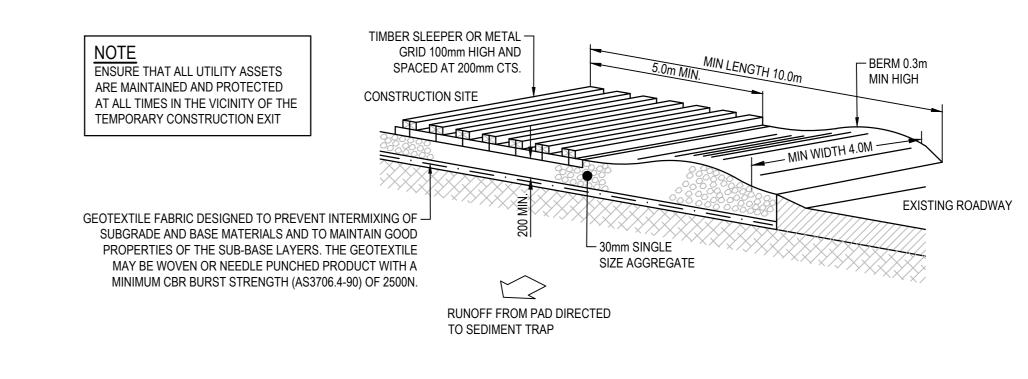

CONSTRUCTION NOTES

1. STRIP TOPSOIL AND LEVEL SITE.

- COMPACT SUBGRADE.
   COVER AREA WITH NEEDLE-PUNCHED GEOTEXTILE.
   CONSTRUCT 200mm THICK PAD OVER GEOTEXTILE USING
- 30mm SINGLE SIZE AGGREGATE.

  5. CONSTRUCT HUMP IMMEDIATELY WITHIN BOUNDARY TO DIVERT WATER TO A SEDIMENT FENCE OR OTHER SEDIMENT TRAP WHERE THE SEDIMENT IS COLLECTED AND REMOVED.

THE EXIT SHALL BE MAINTAINED IN A CONDITION WHICH PREVENTS TRACKING OR FLOWING OF SEDIMENT OFF THE CONSTRUCTION SITE. THIS MAY REQUIRE PERIODIC TOP DRESSING WITH ADDITIONAL GRAVEL AS CONDITIONS DEMAND AND REPAIR AND/OR CLEANOUT OF ANY MEASURES USED TO TRAP SEDIMENT. ALL SEDIMENT SPILLED, DROPPED, WASHED OR TRACKED OFF THE CONSTRUCTION SITE MUST BE REMOVED IMMEDIATELY.

MAINTENANCE NOTES

TEMPORARY STABILISED CONSTRUCTION EXIT

B ISSUE FOR SSDA 22.03.22 RG MB
A ISSUE FOR SSDA 14.03.22 RG MB
No. Description Date By Chk

Lead Consultant / MEP / Structures

LCI CONSULTANTS
(AUSTRALIA) PTY LTD


LEVEL 4, 73 W
NORTH SYL
ABI

p:po box 5036 west chatswood nsw 1515 t: (02) 8966 6000 w:www.dem.com.au

box 5036 west chatswood nsw 1515
2) 8966 6000
20 w.dem.com.au

CONSULTANTS



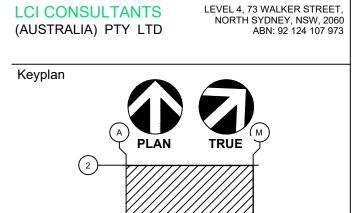

Project
SYD08 DATA CENTRE
57 STATION ROAD
SEVEN HILLS, NSW 2147
Drawing Title


DETAILS SHEET 3


Drawing No.


Status ISSUE FOR SSDA
Scale @ A0
AS SHOWN

NSW202013\_C101.07

COMMERCIAL IN CONFIDENCE

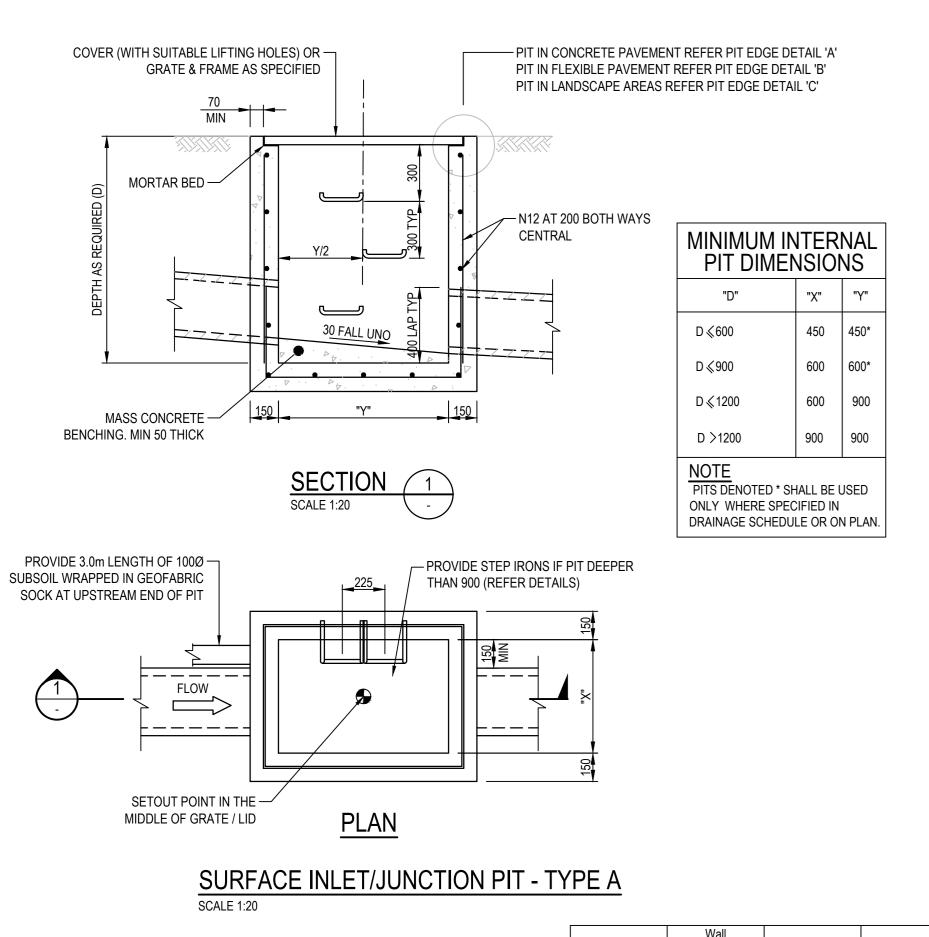

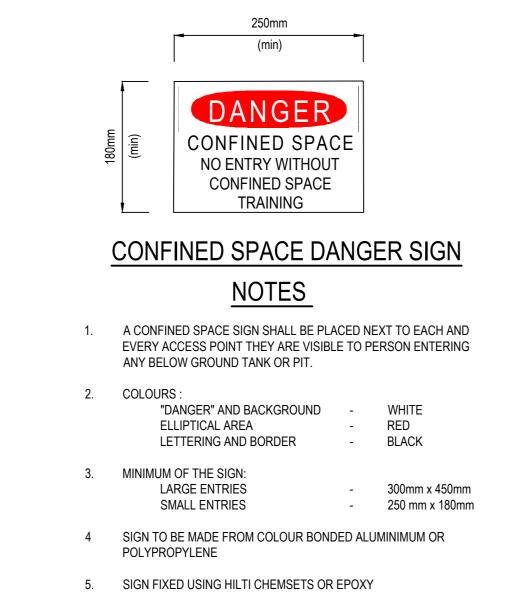


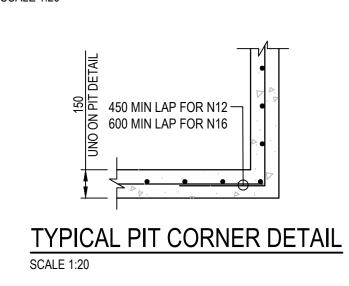


<sup>⊕</sup> |A0

Span <= 1.5m	Wall Dimensions (mm)				
Depth "h"	Base thickness "d"	Wall thickness "w"	Vertical reinf.	Hor.reinf.	Base Reinf. BW
up to 2m	150.0	150.0	N12@200	N12@200	N12@200
up to 4m	200.0	175.0	N12@200	N12@200	N12@200
up to 6m	200.0	200.0	N12@200	N12@200	N12@200
up to 8m	230.0	230.0	N16@200	N16@200	N16@200
Span 1.5 to 2.5m	Wall Dimensions (mm)				
Depth "h"	Base thickness "d"	Wall thickness "w"	Vertical reinf.	Hor.reinf.	Base Reinf. BW
up to 2m	150.0	200.0	N12@200	N12@200	N12@200
up to 4m	200.0	200.0	N16@200	N16@200	N16@200
up to 6m	230.0	230.0	N16@200	N16@200	N16@200
up to 8m	250.0	250.0	N16@200	N16@200	N16@200

PIT DIMENSION TABLE NOTE: FOR PIT DIMENSIONS AND REINFORCEMENT REFER TABLE ABOVE

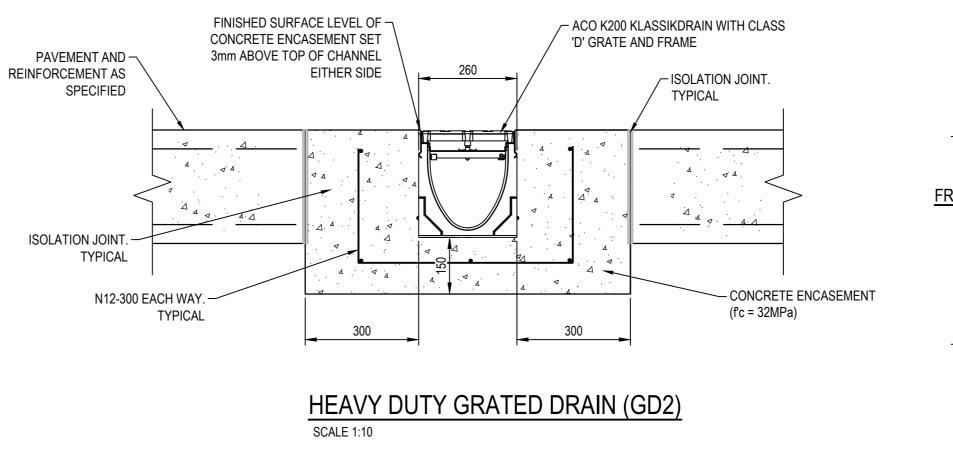

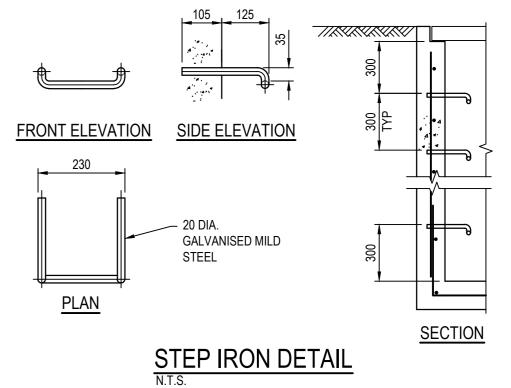

NOTE: WHERE STEP IRONS WILL BE FULLY SUBMERGED, 306 STAINLESS STEEL STEP IRONS SHALL BE USED OR OTHER APPROVED STEP IRON

COMMERCIAL IN CONFIDENCE


22.03.22 RG MB B ISSUE FOR SSDA 14.03.22 RG MB A ISSUE FOR SSDA No. Description Date By Chk

Lead Consultant / MEP / Structures LEVEL 4, 73 WALKER STREET, NORTH SYDNEY, NSW, 2060 ABN: 92 124 107 973

(AUSTRALIA) PTY LTD

p:po box 5036 west chatswood nsw 1515 t: (02) 8966 6000 w:www.dem.com.au  $\operatorname{dem}$ CONSULTANTS



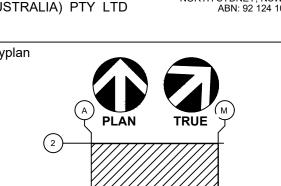


SYD08 DATA CENTRE 57 STATION ROAD SEVEN HILLS, NSW 2147


Drawing Title DETAILS SHEET 4


ISSUE FOR SSDA AS SHOWN


Drawing No.


NSW202013\_C101.08

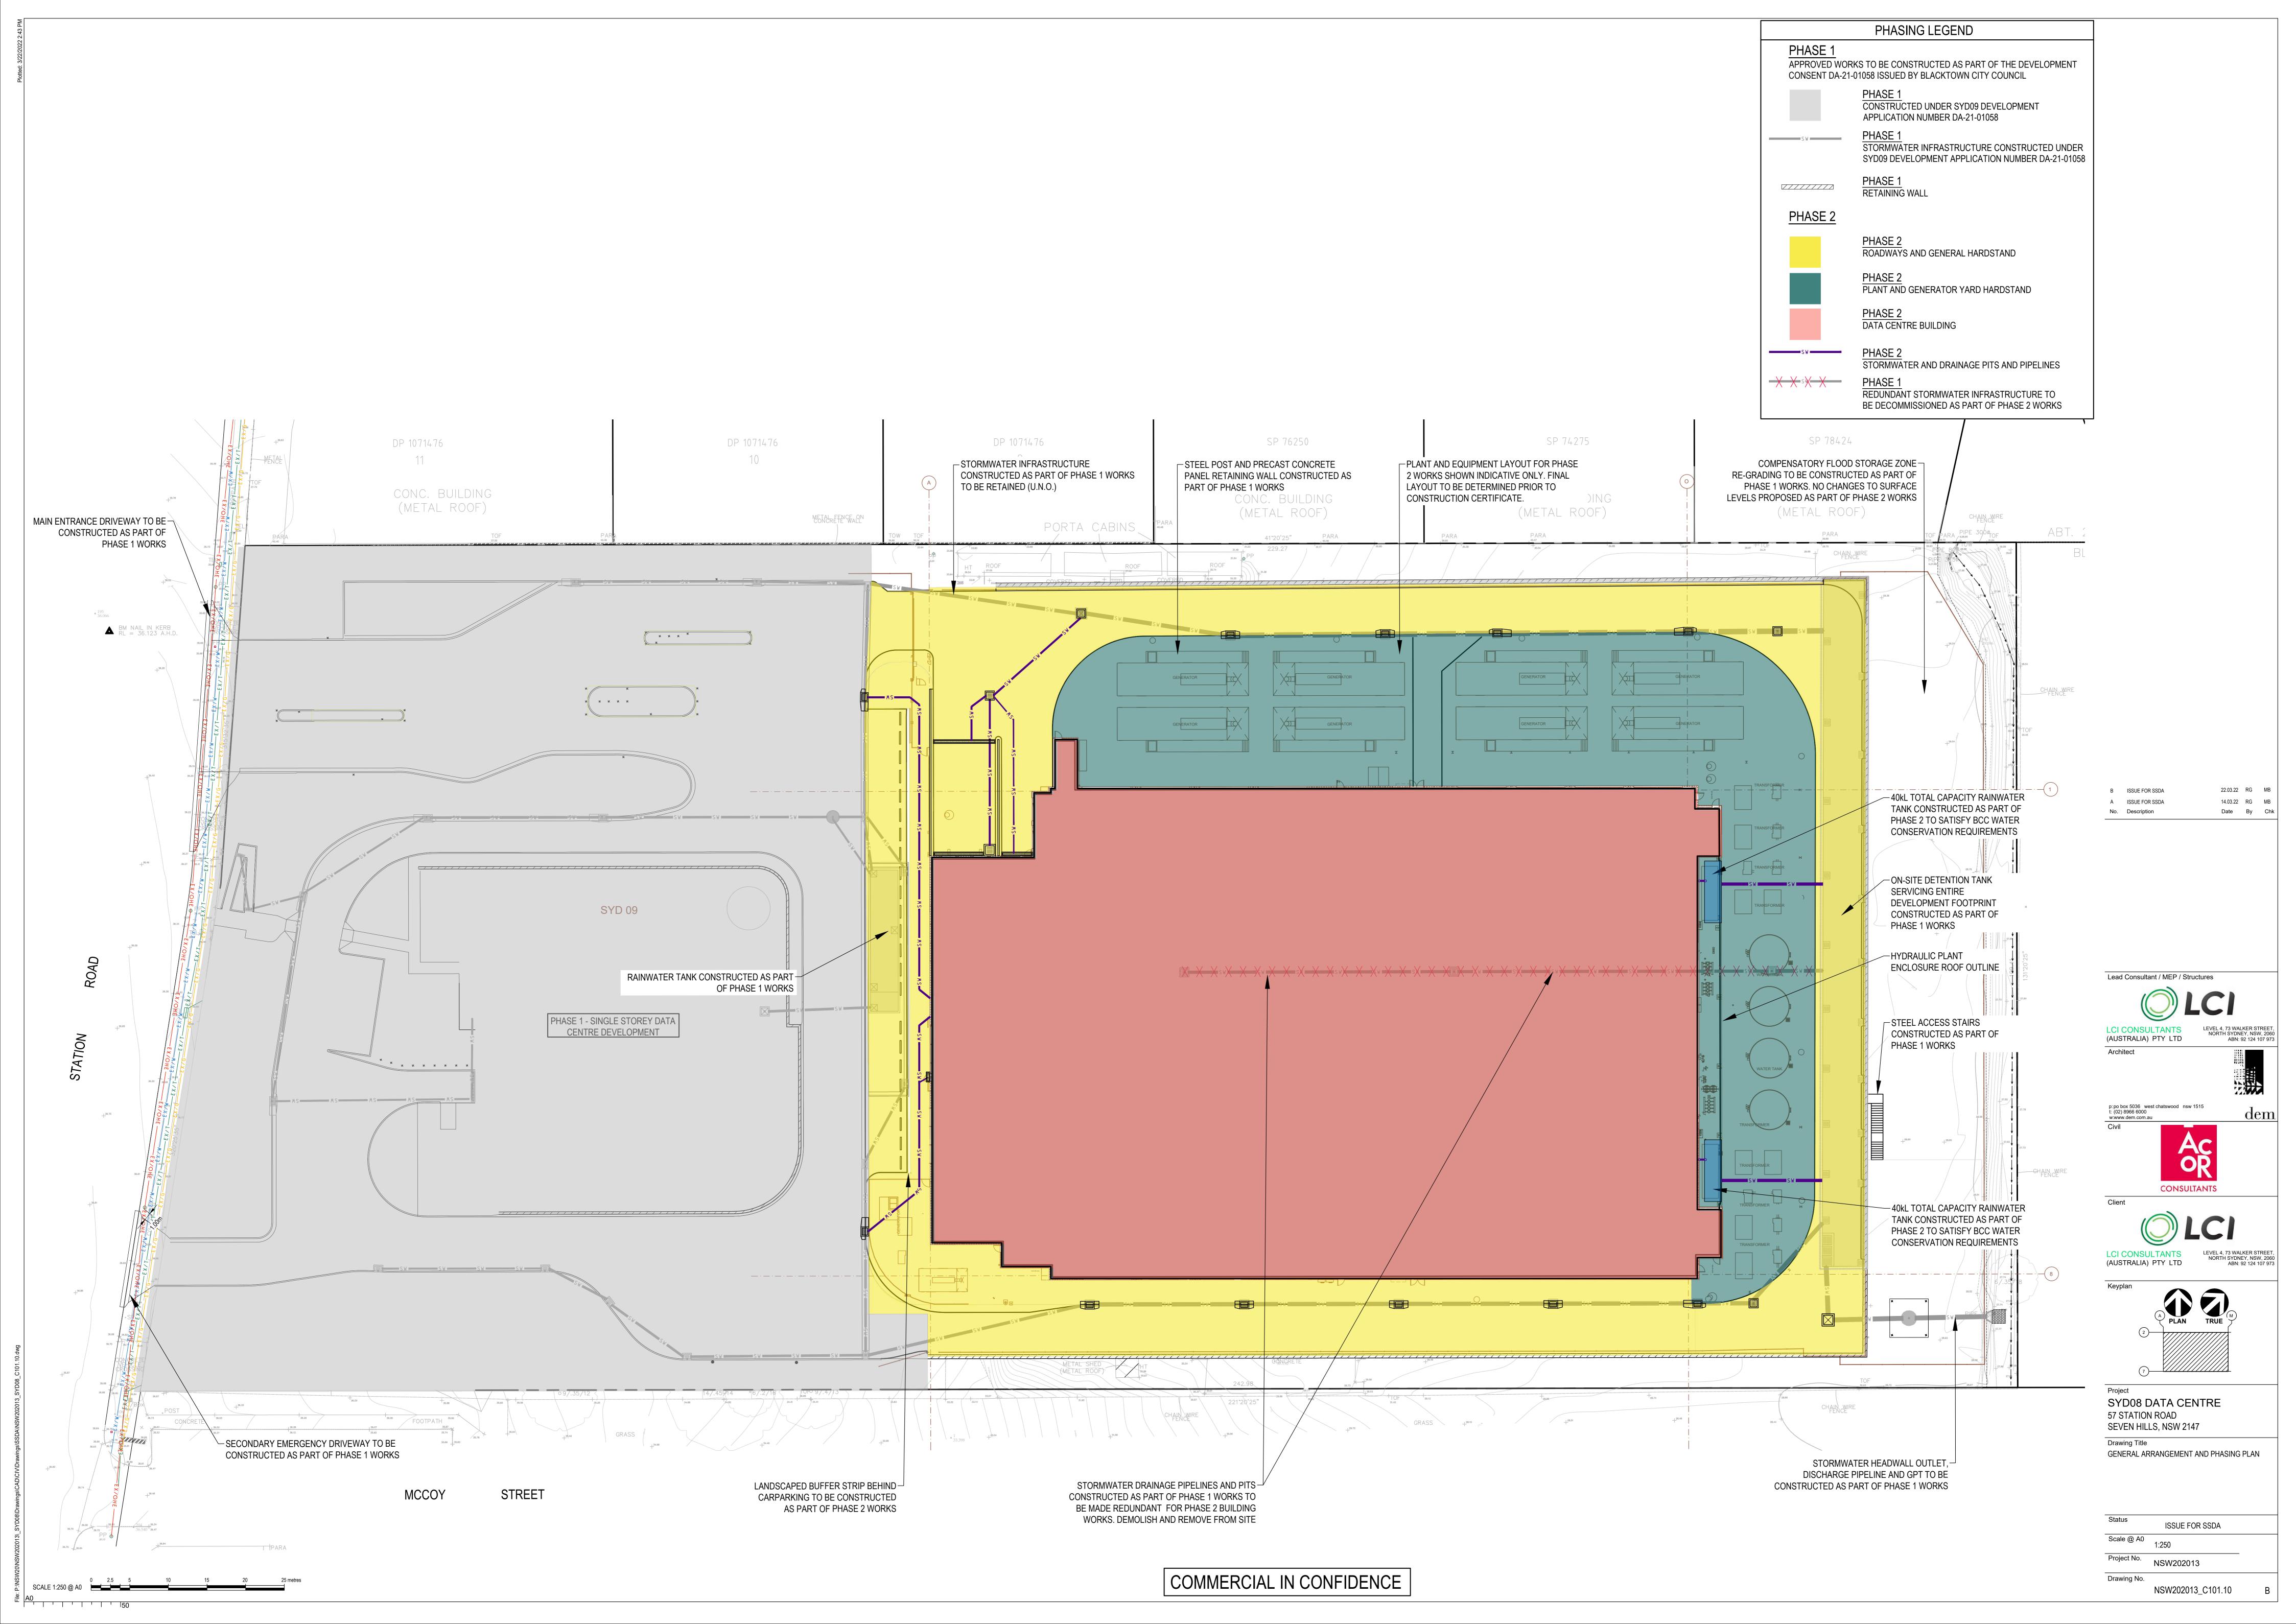


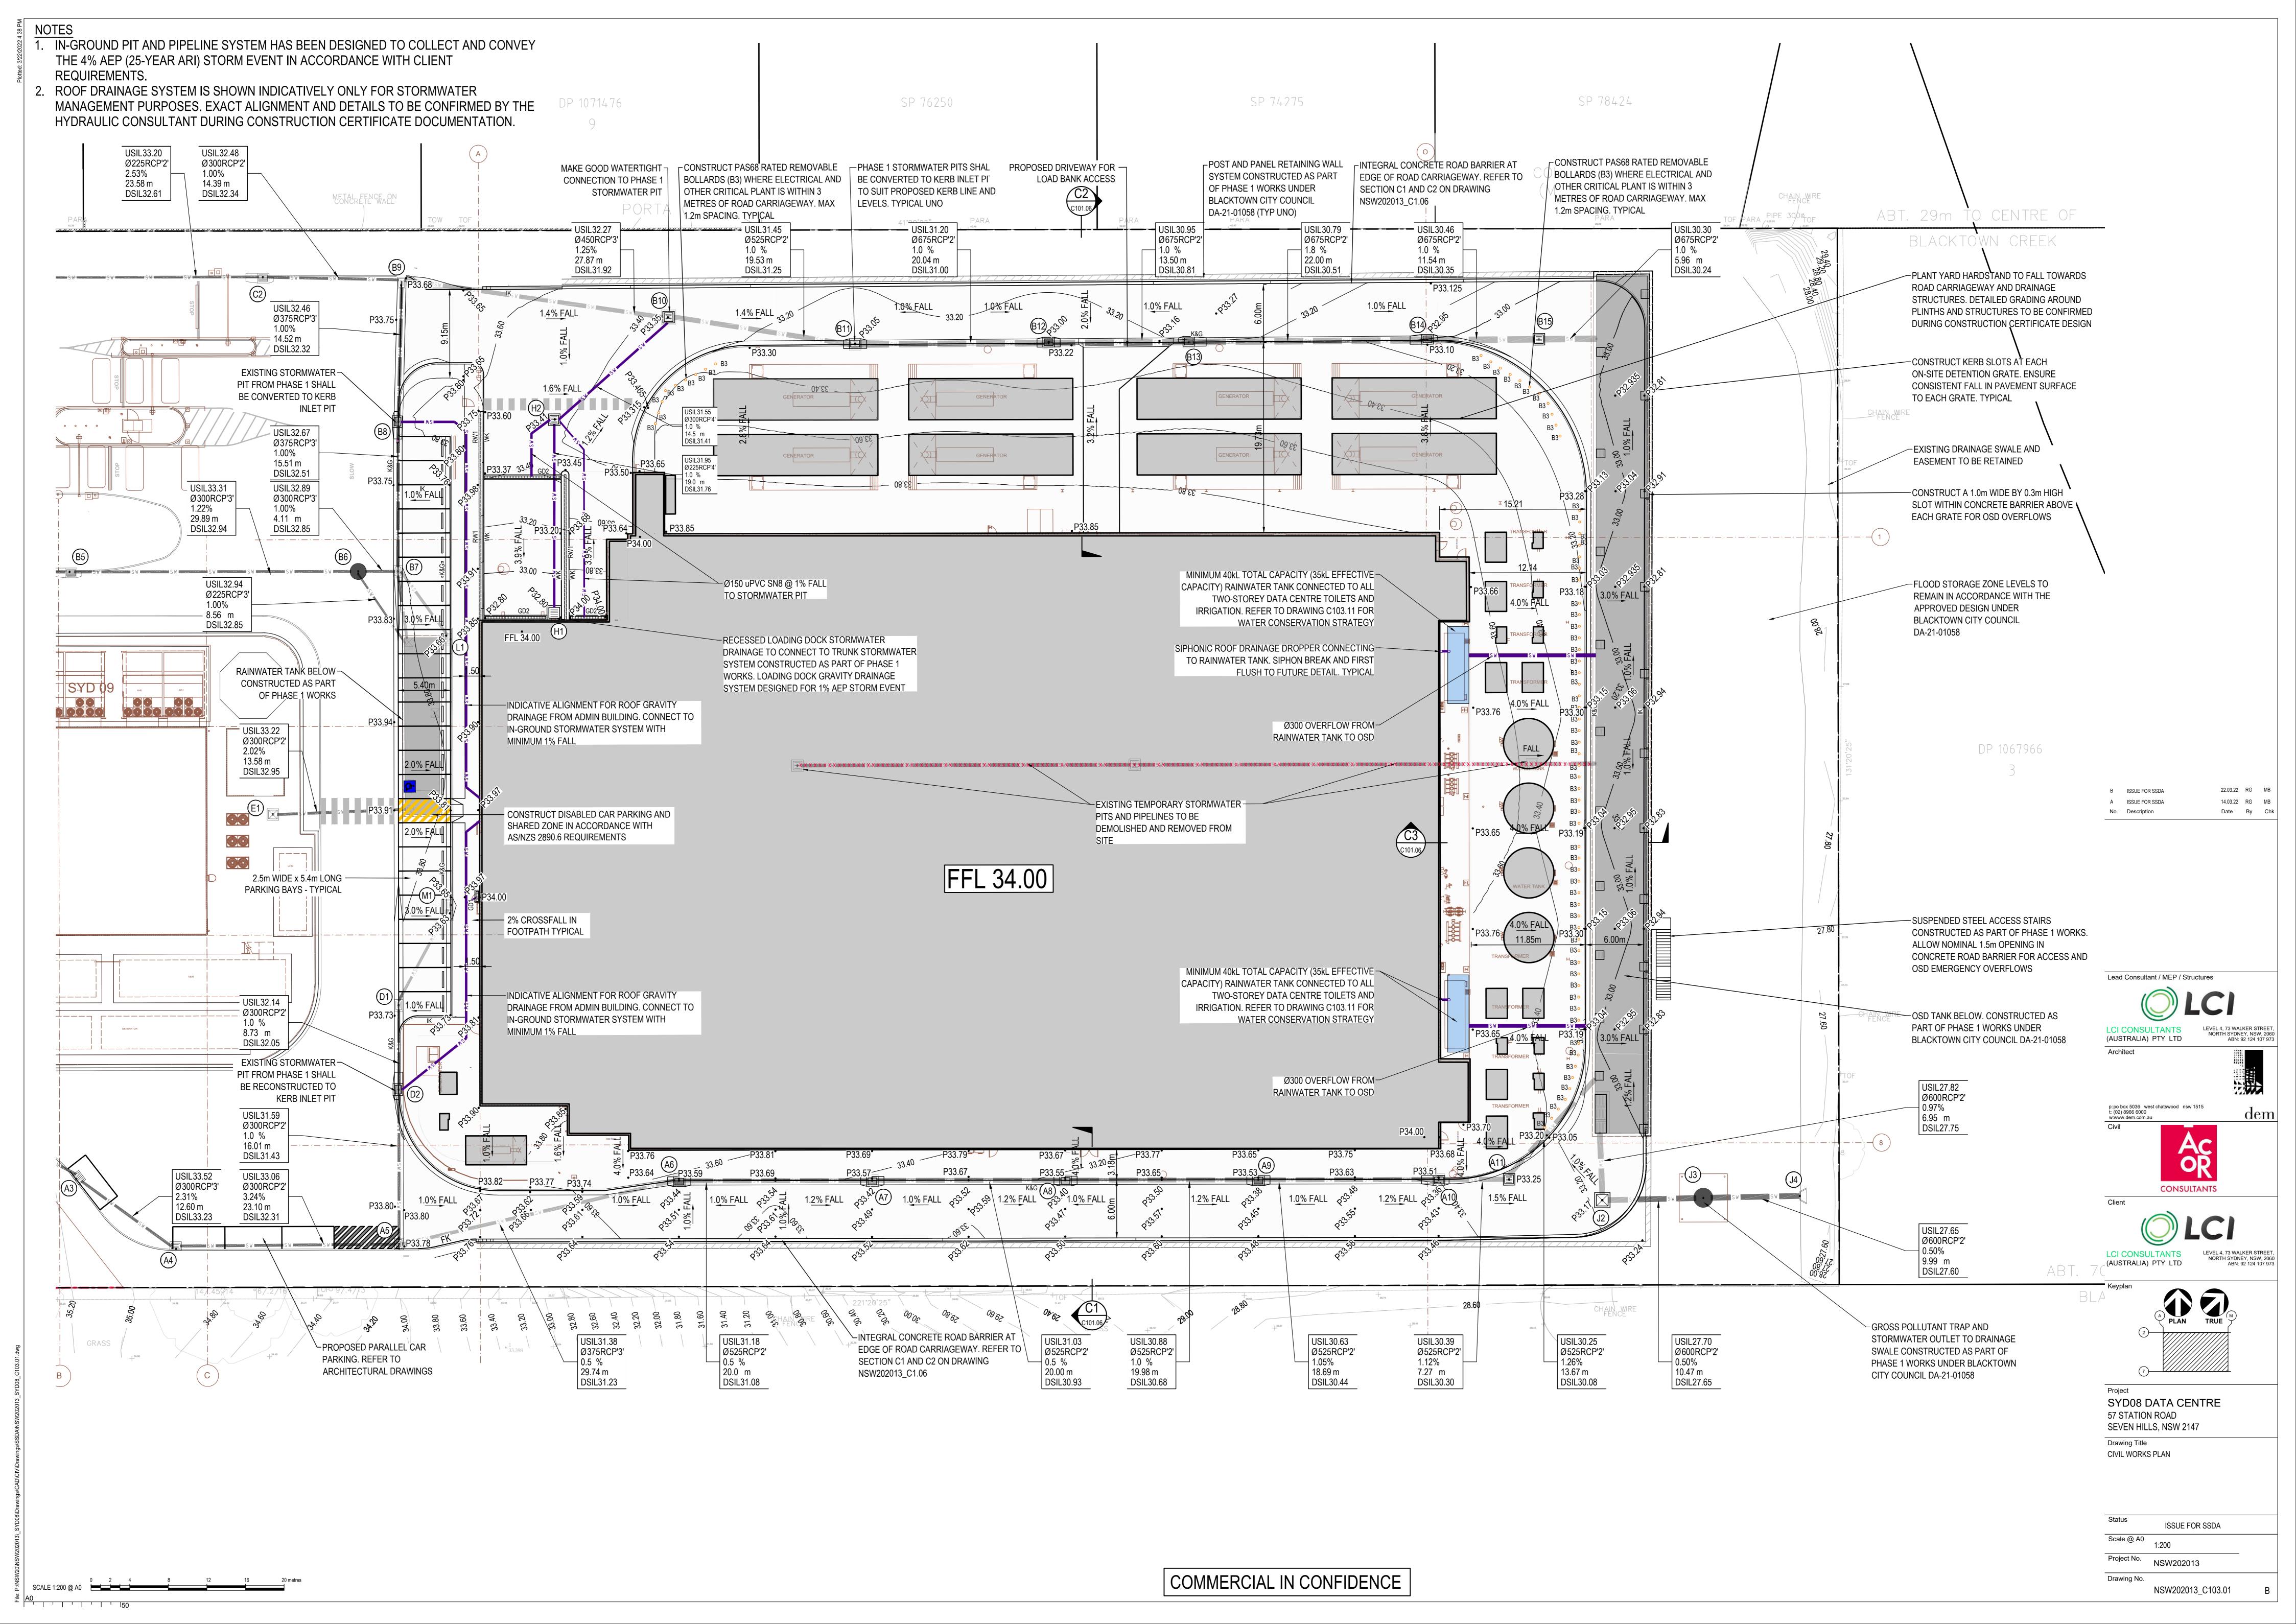


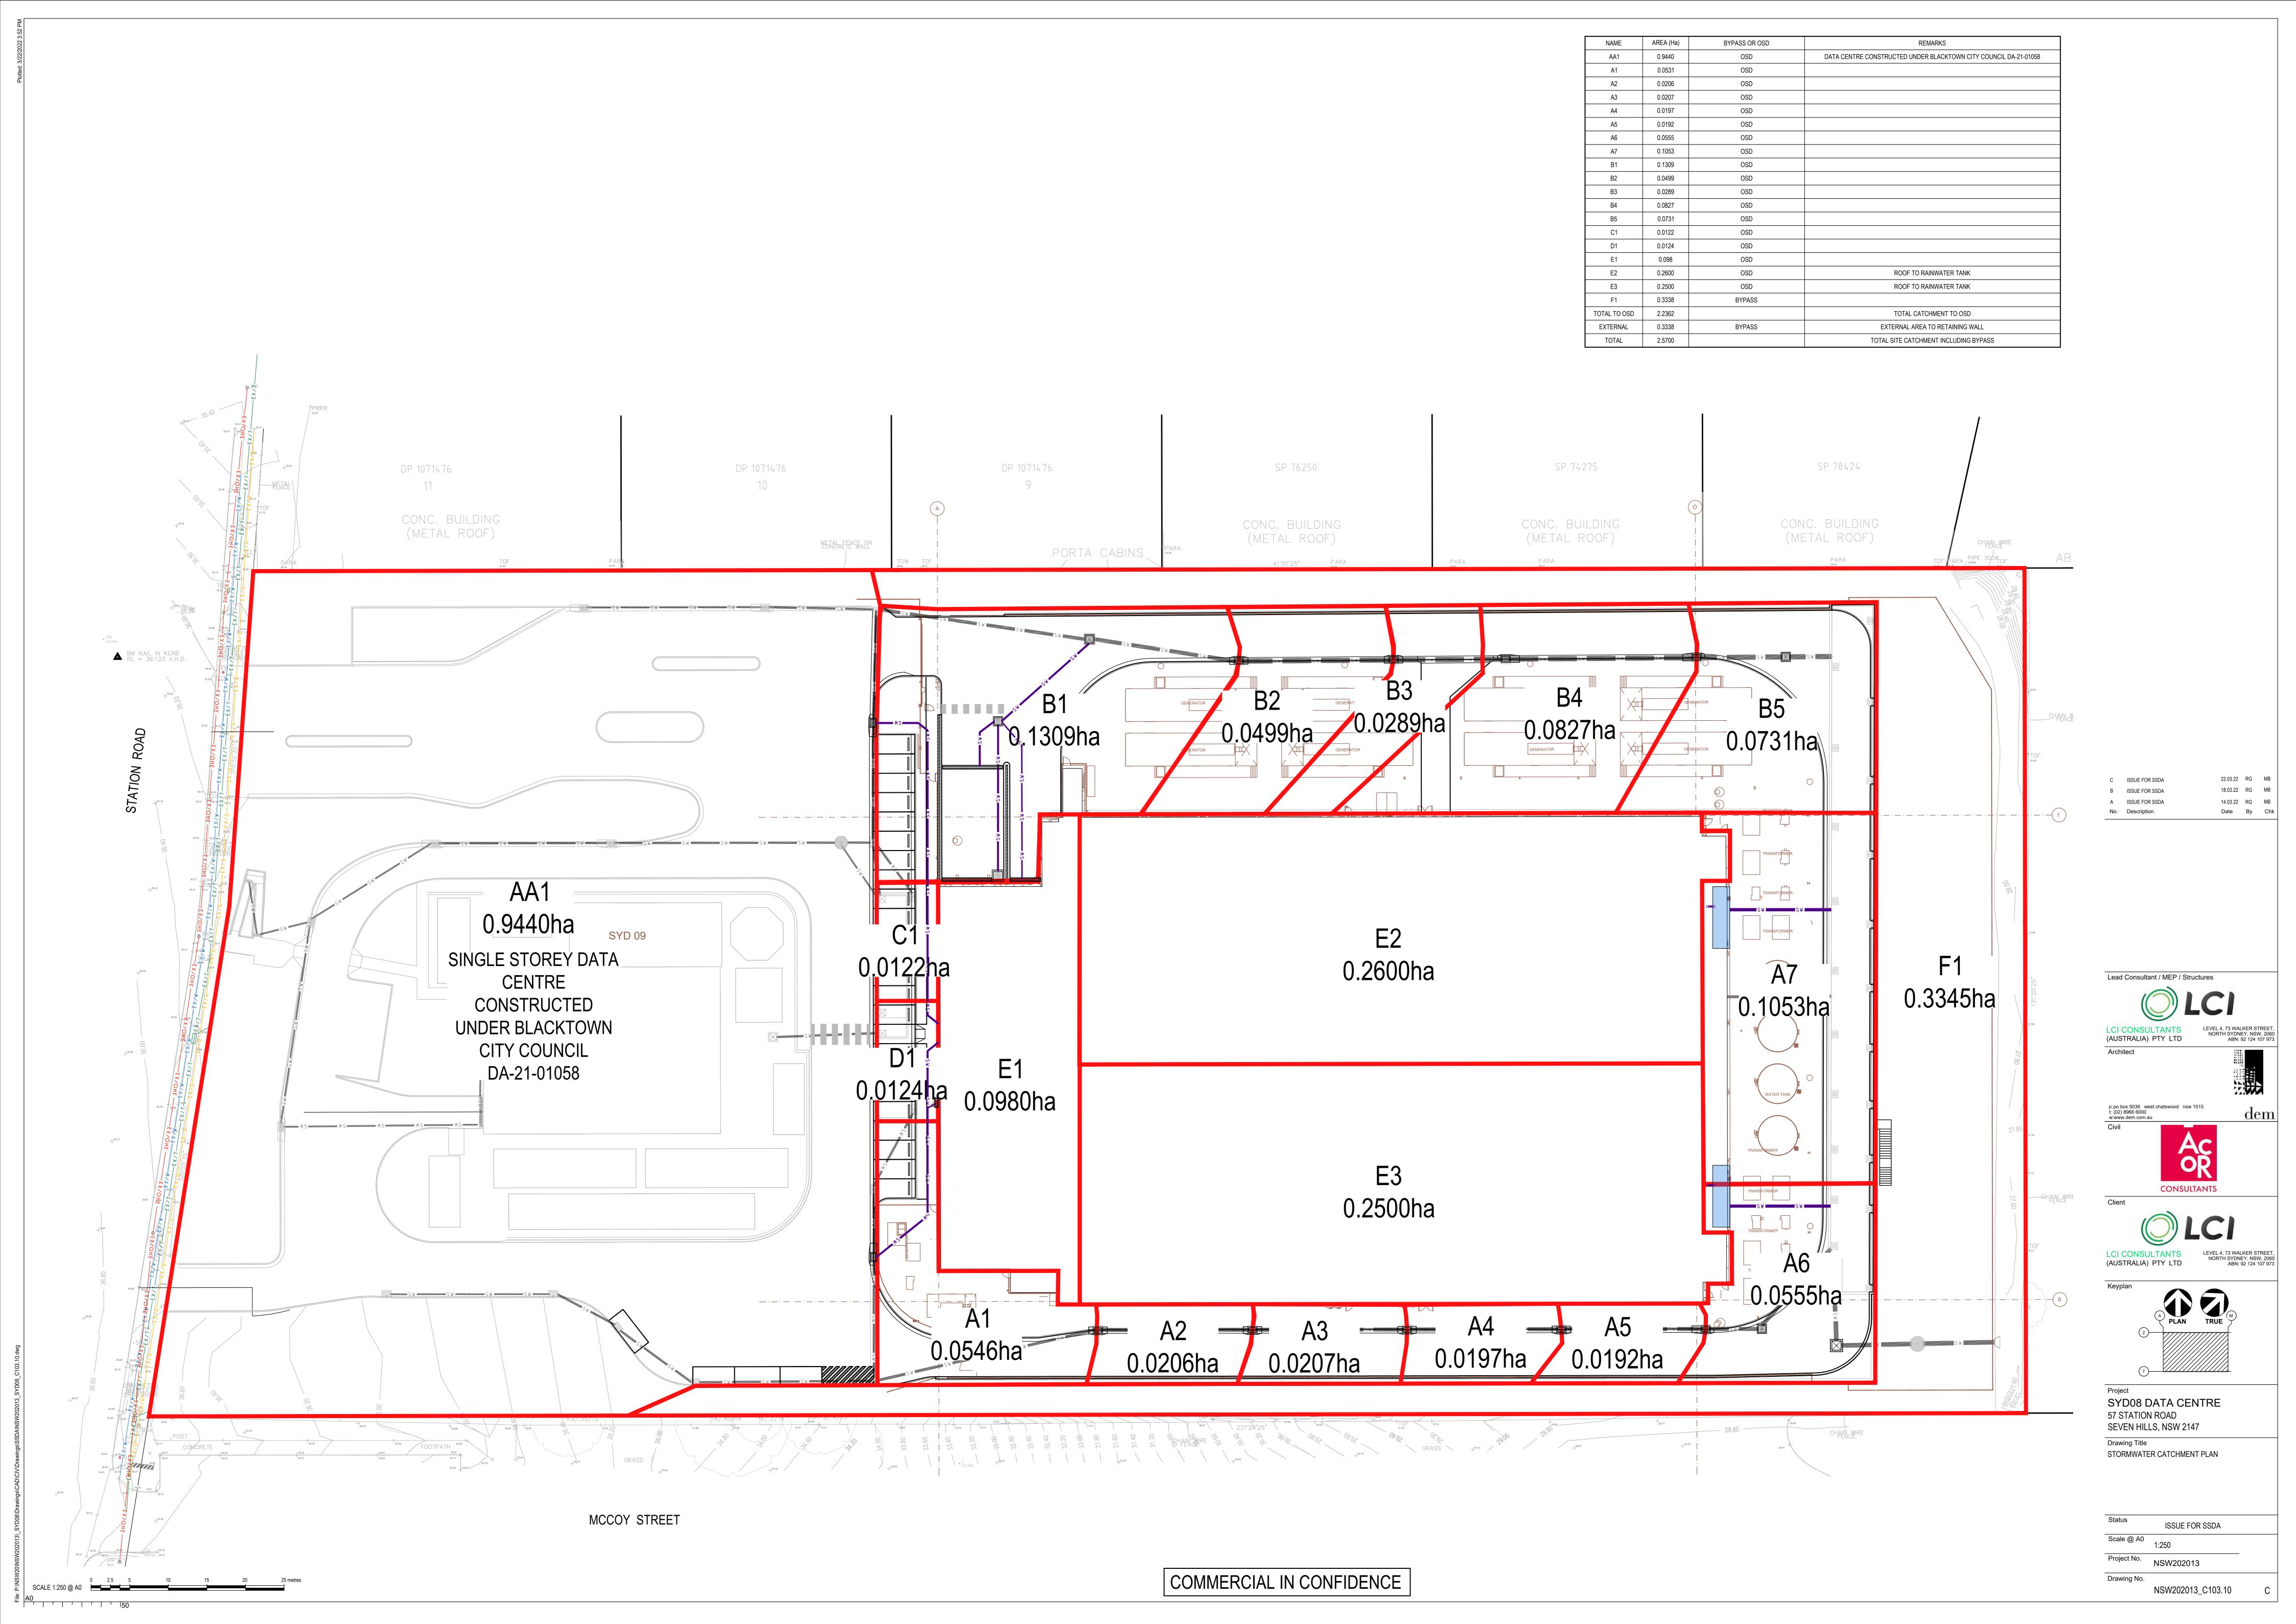


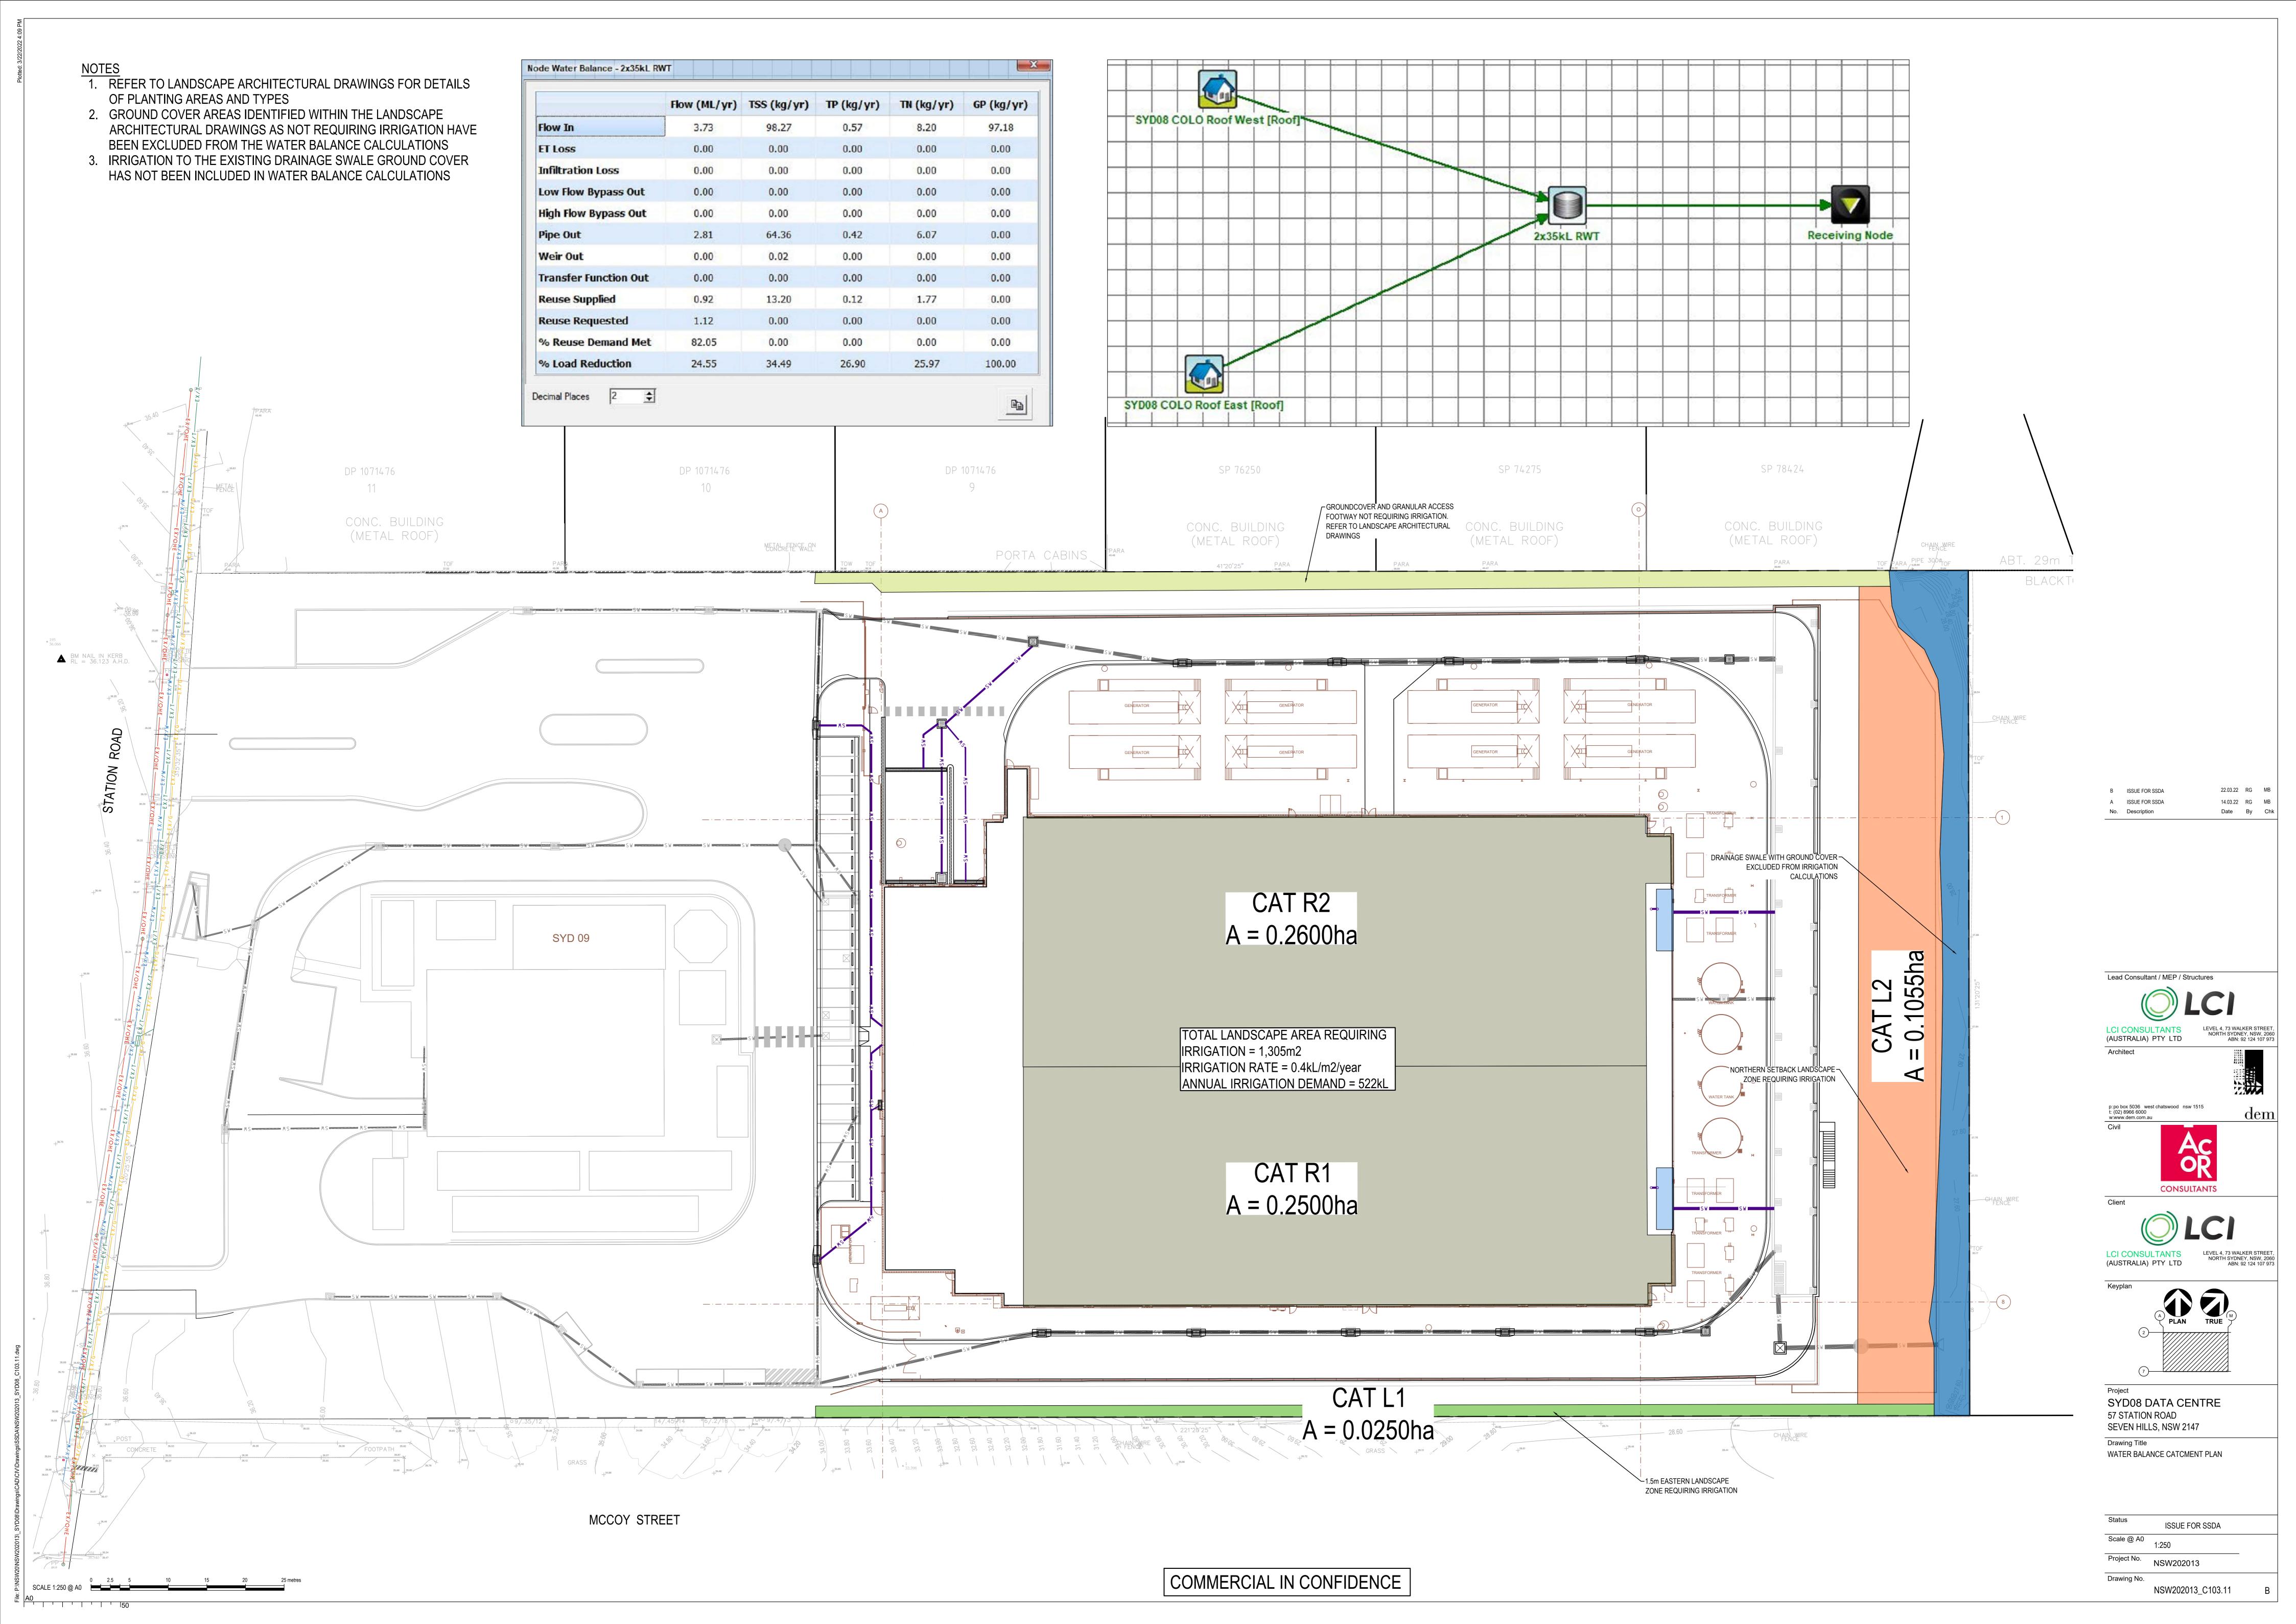


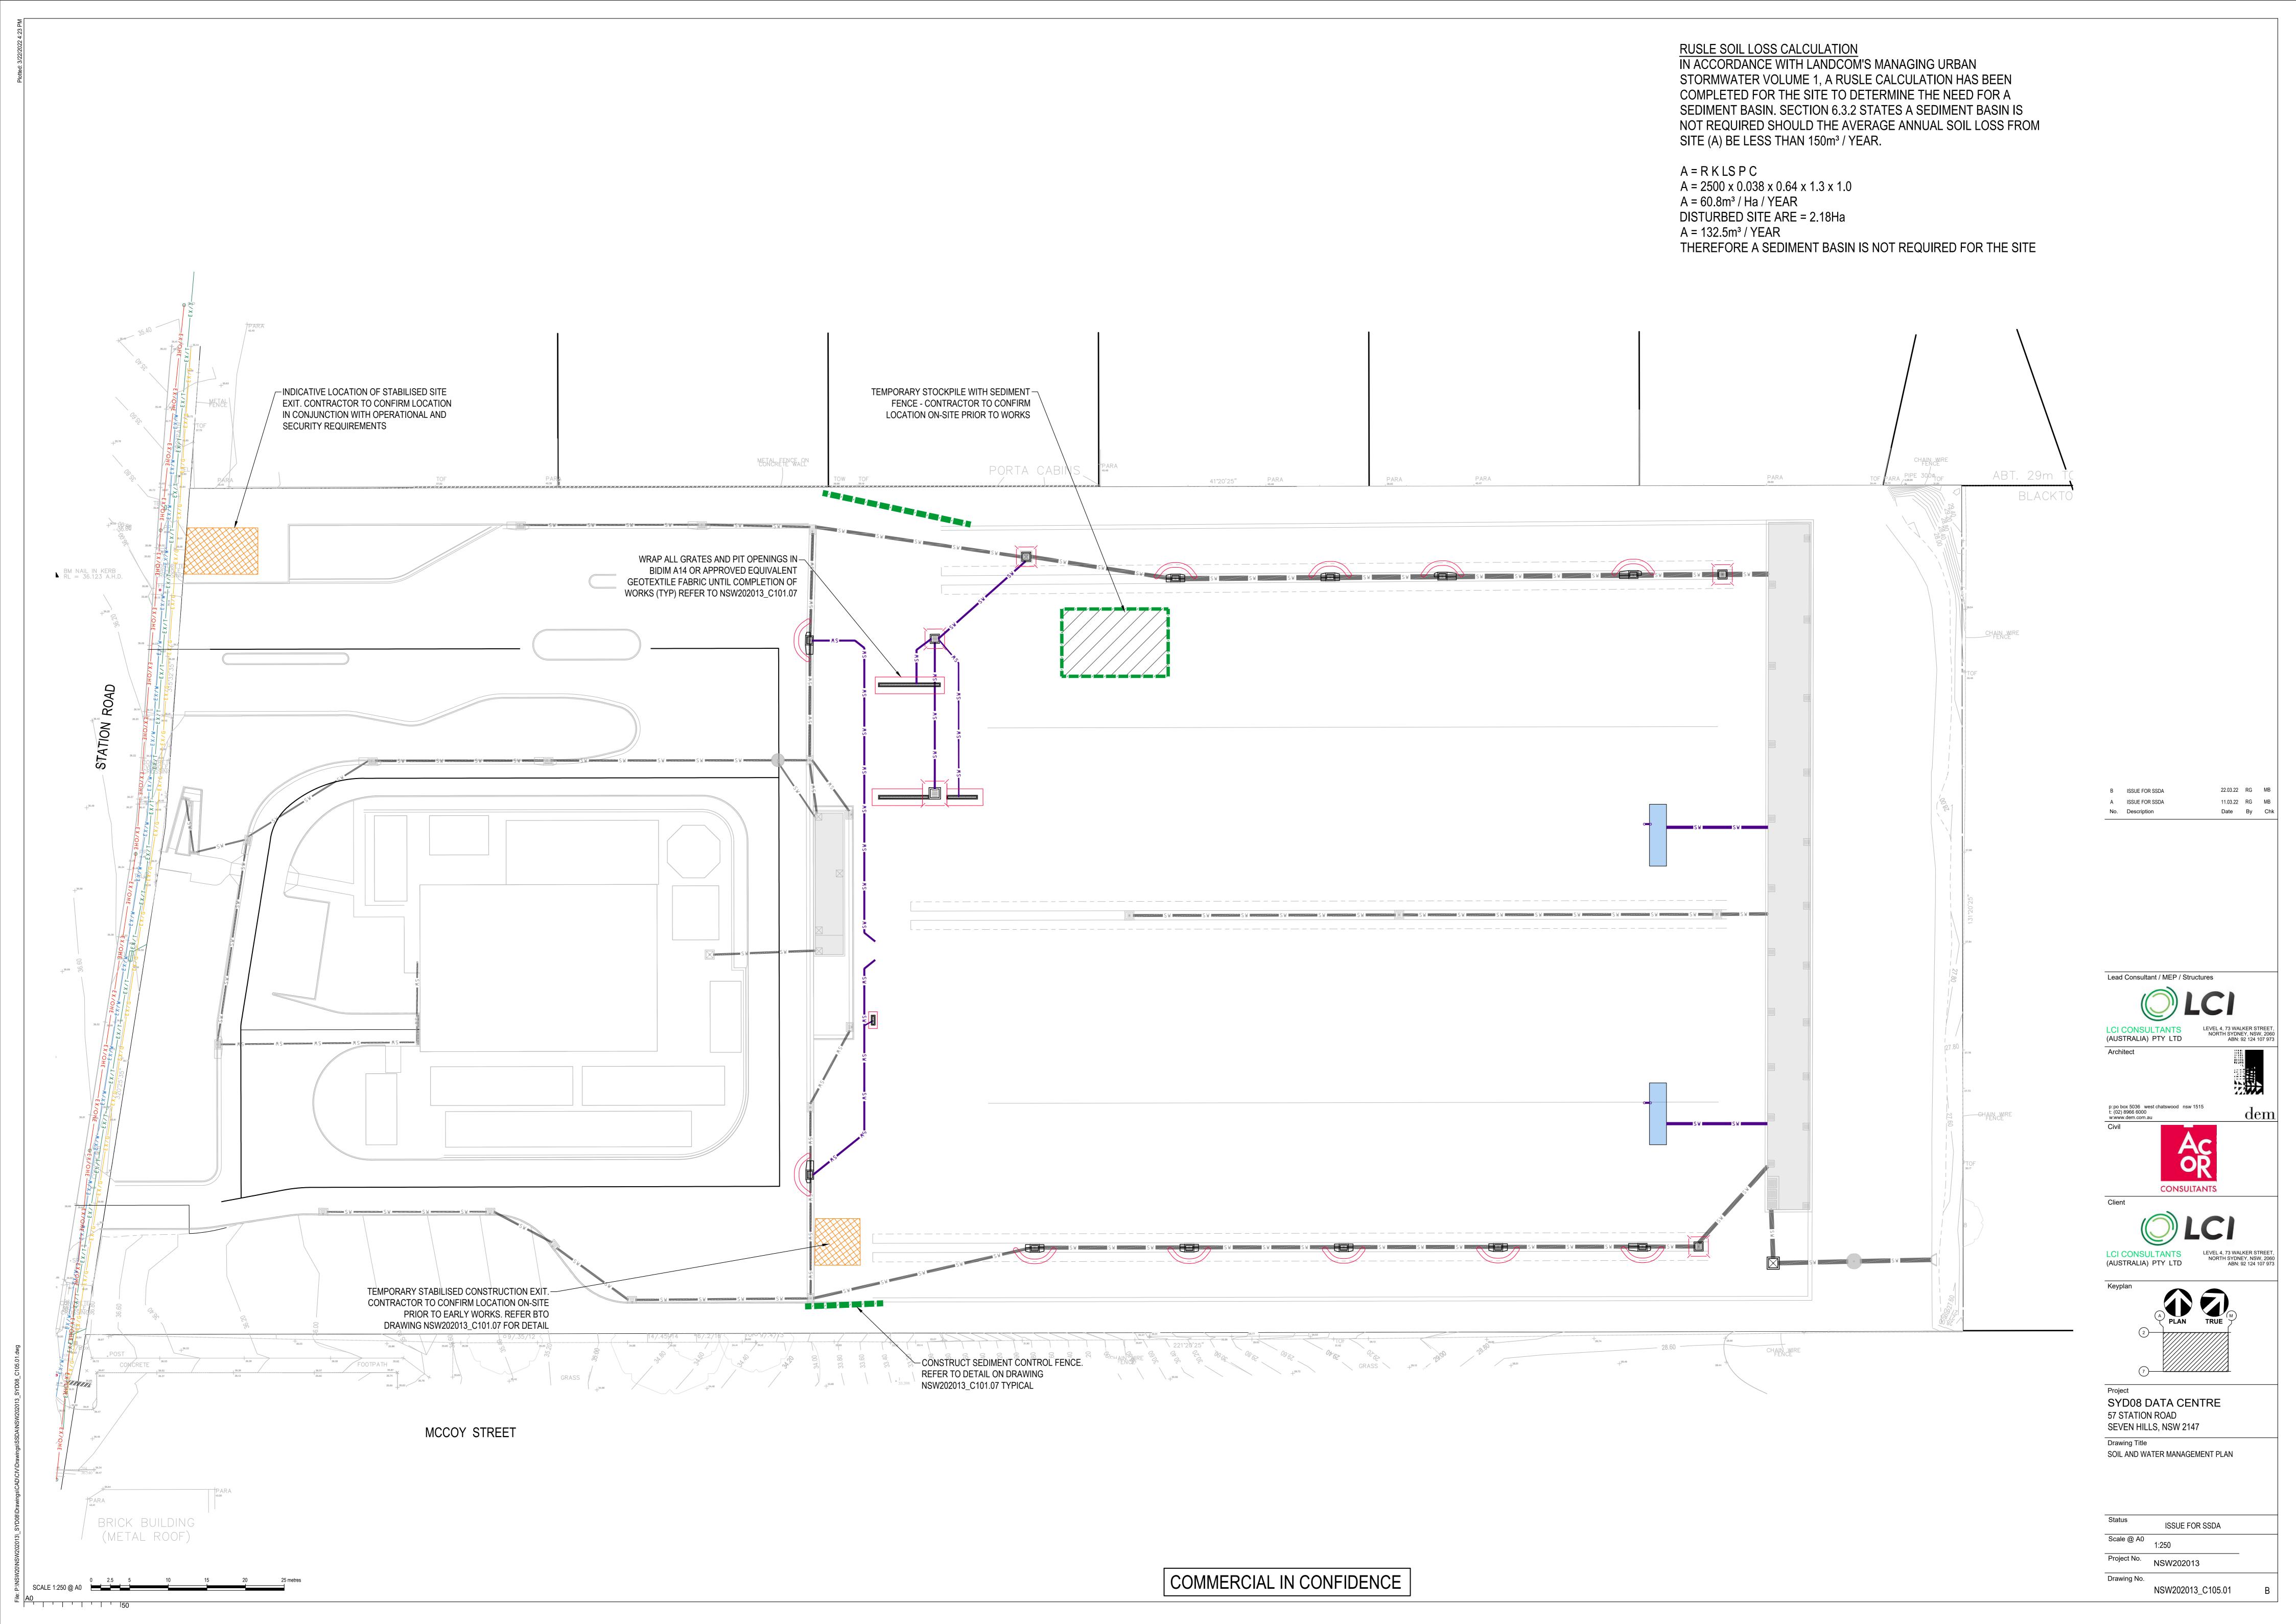


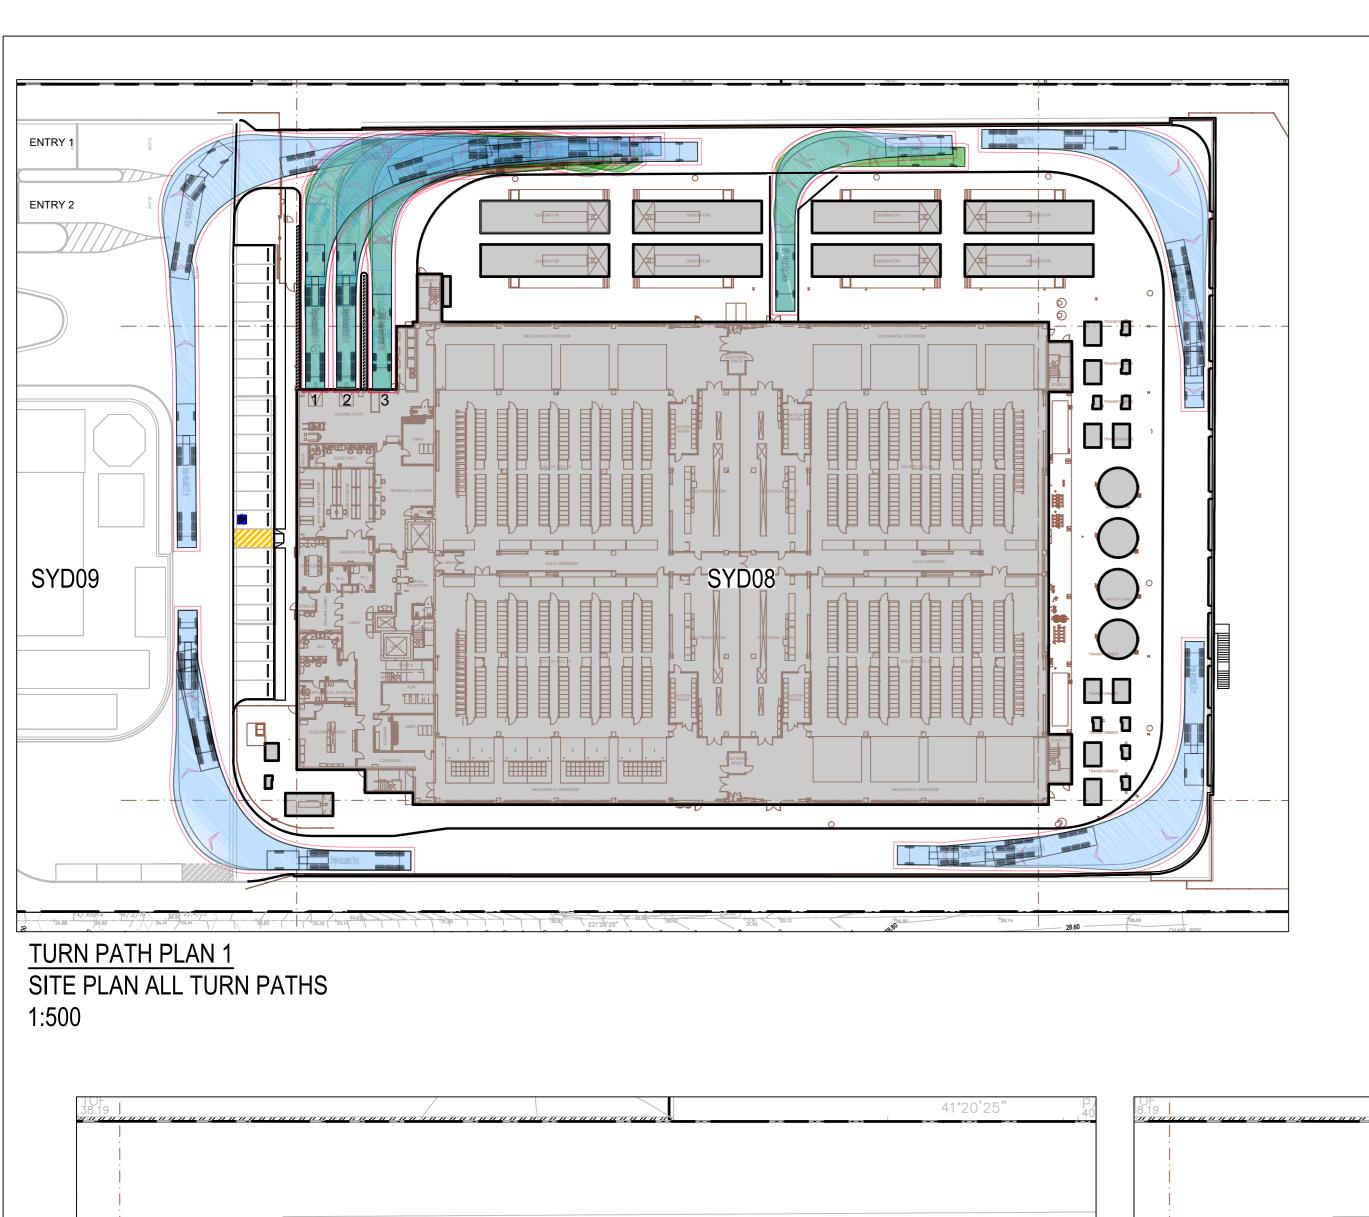


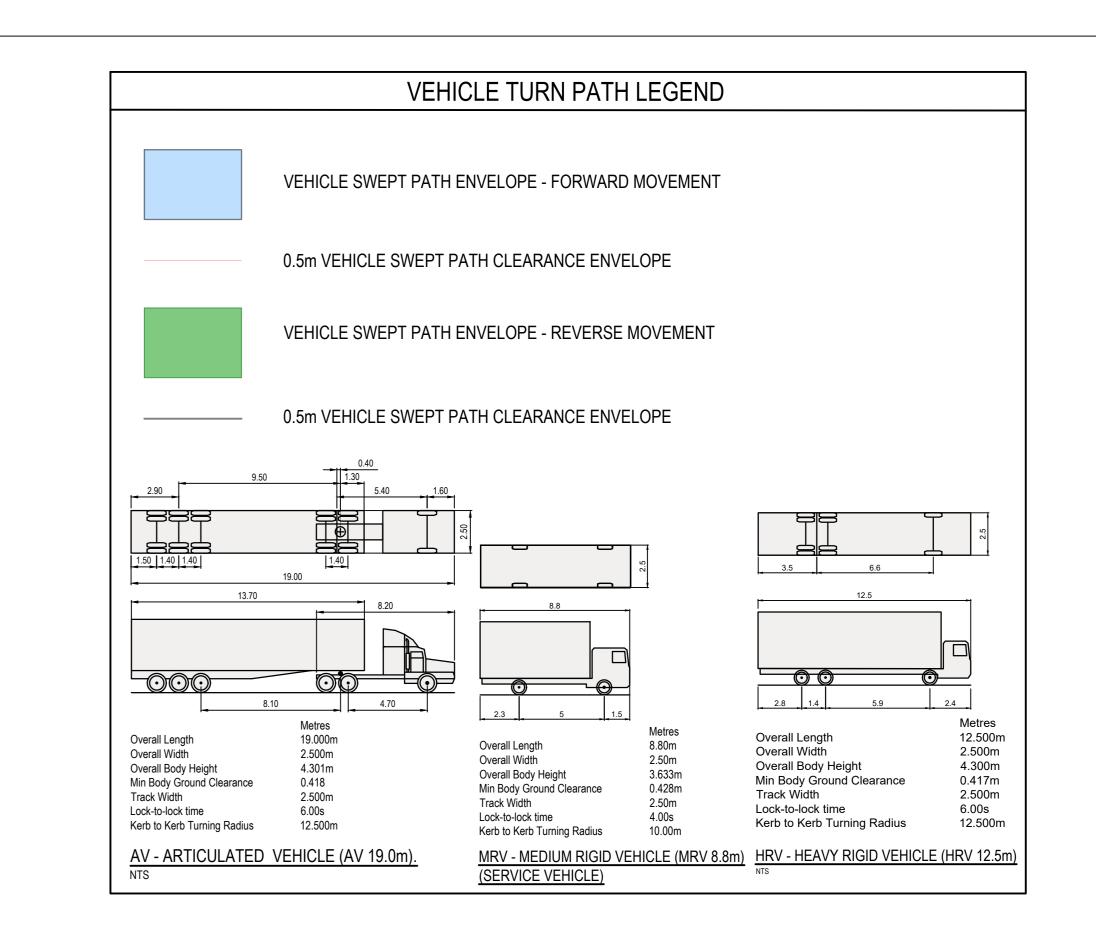

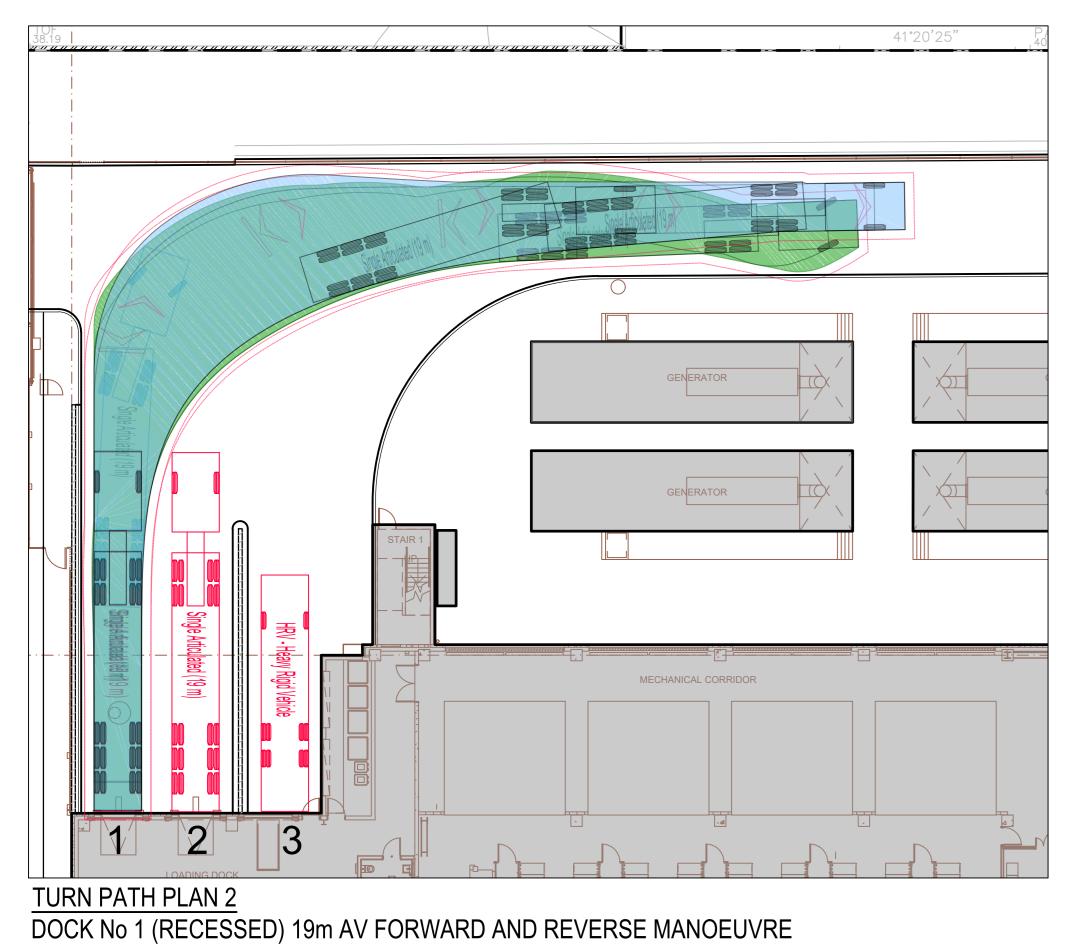


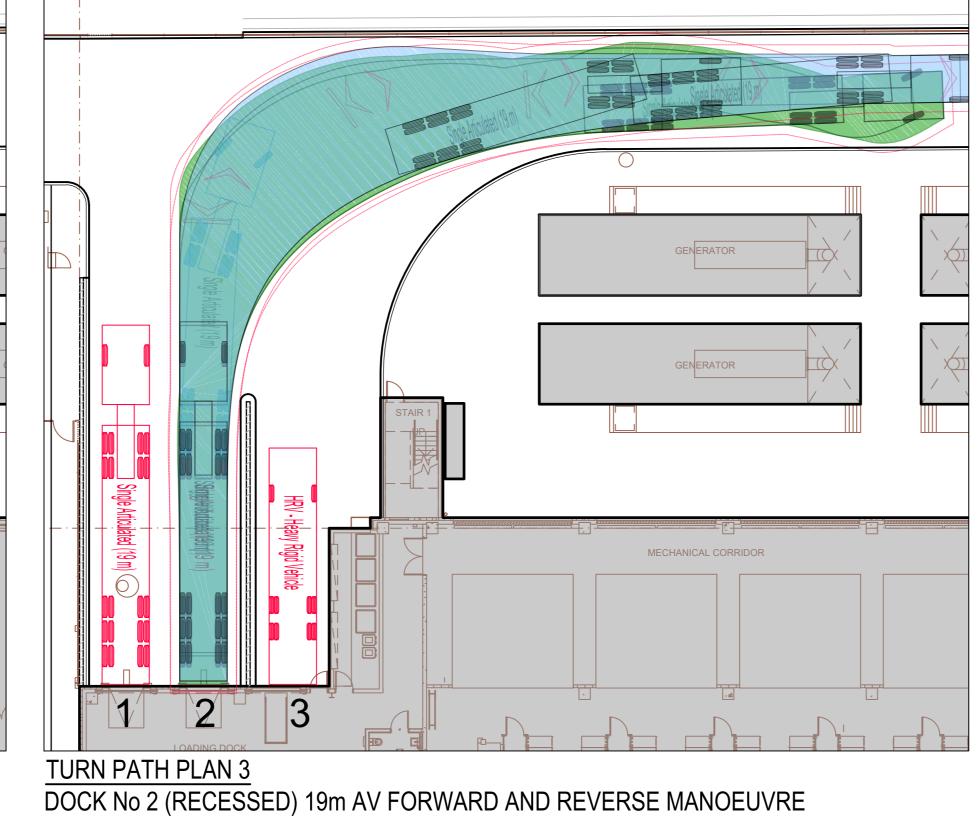


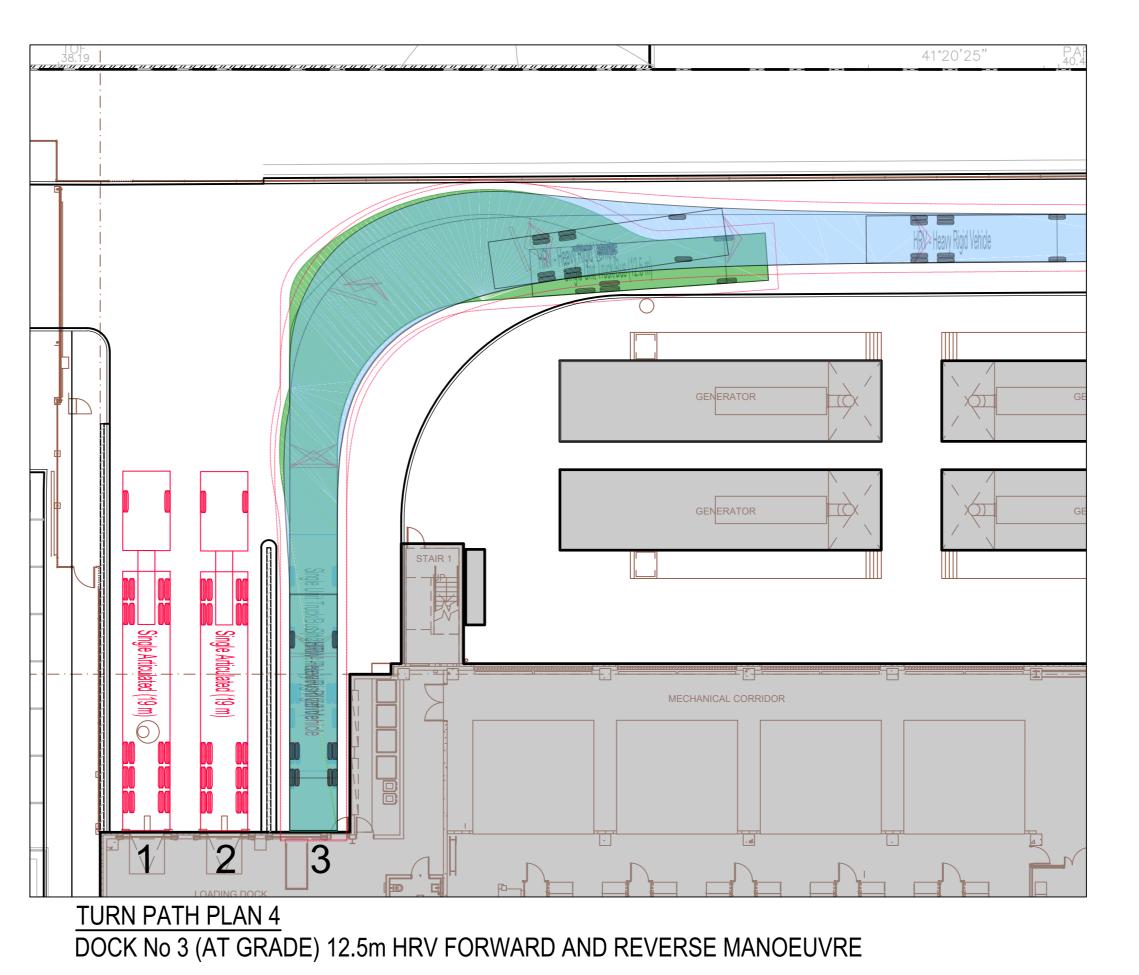


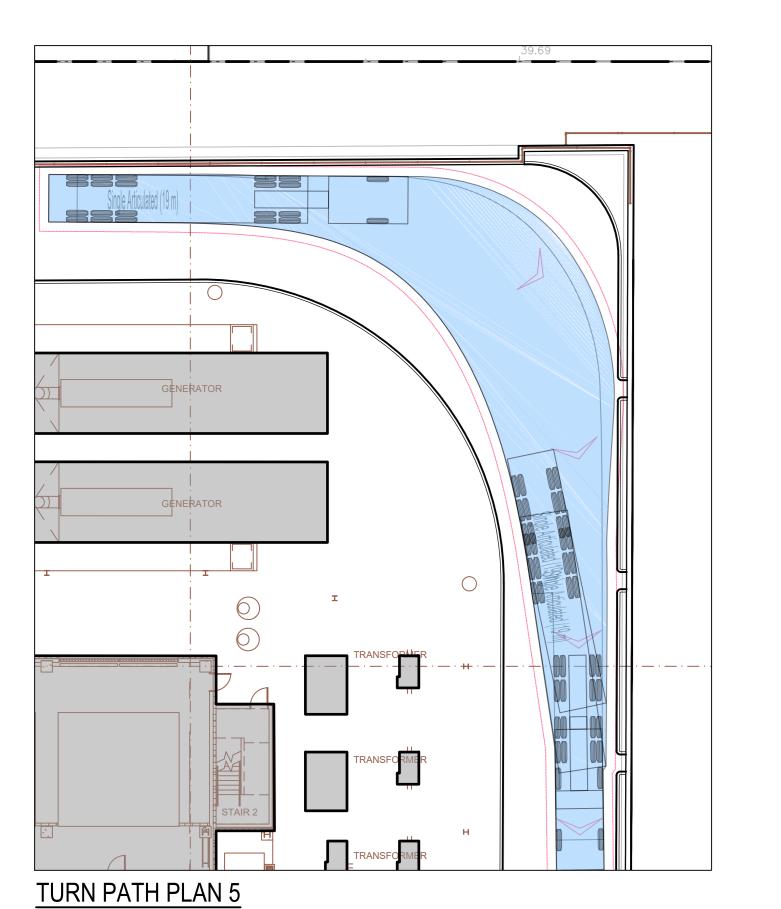


19m AV FORWARD MANOEUVRE NORTH WEST CORNER

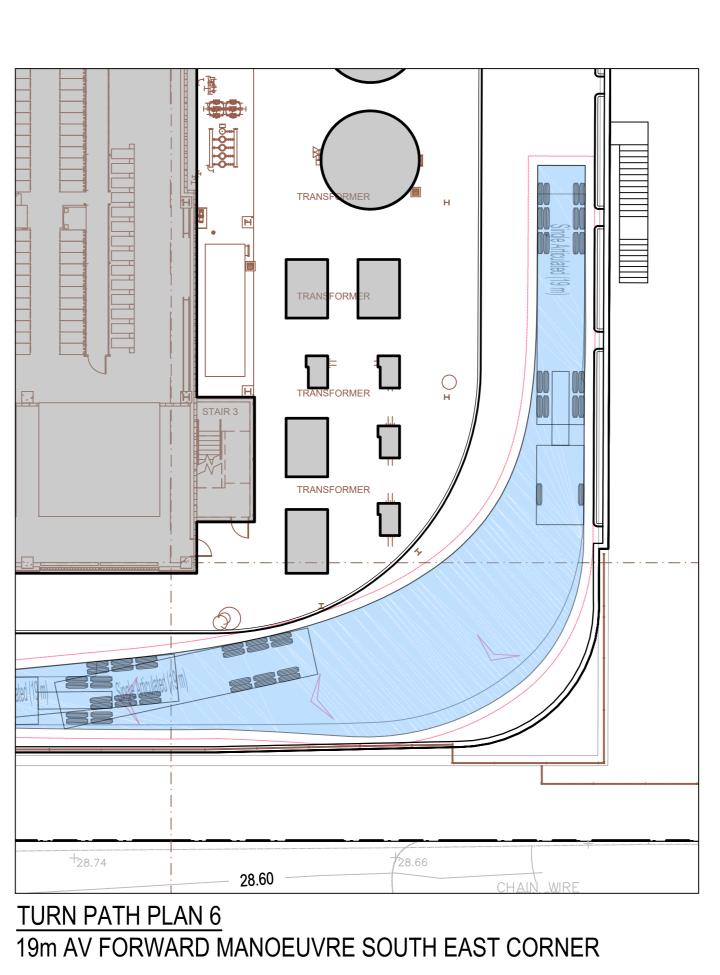

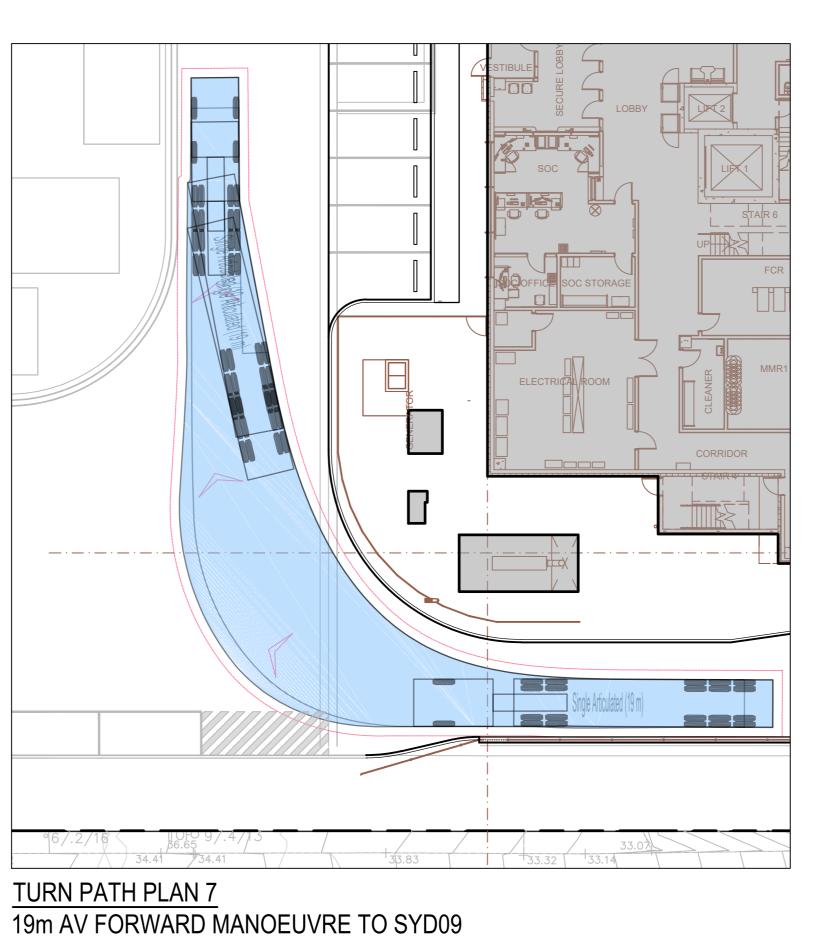


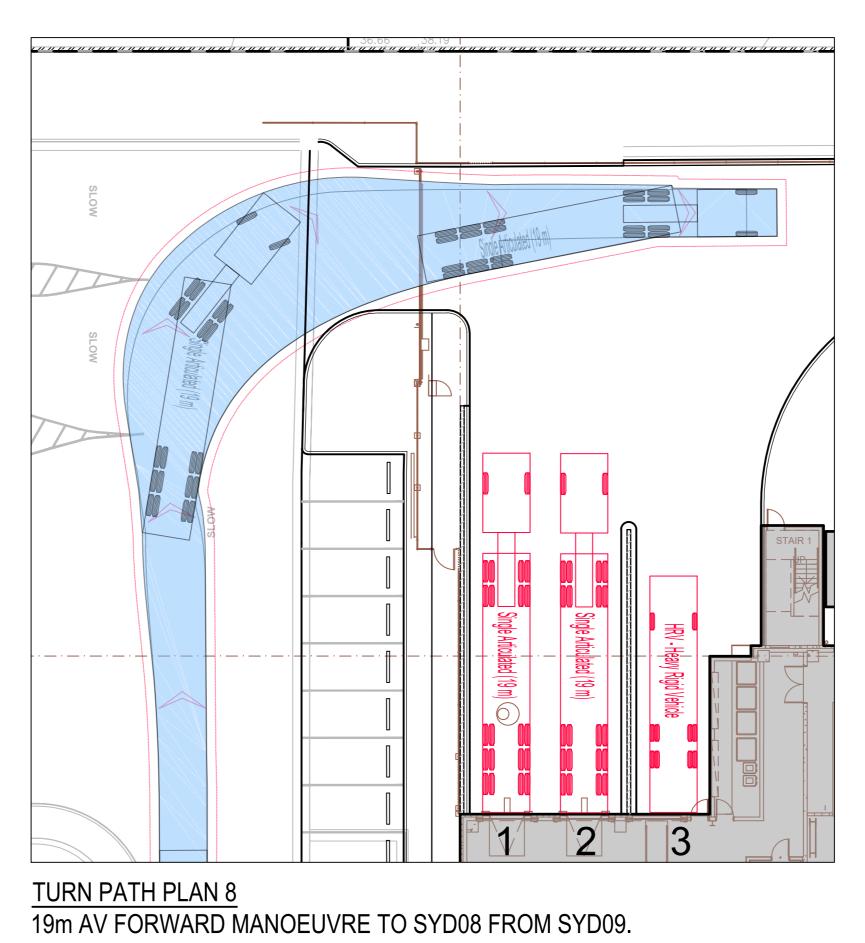

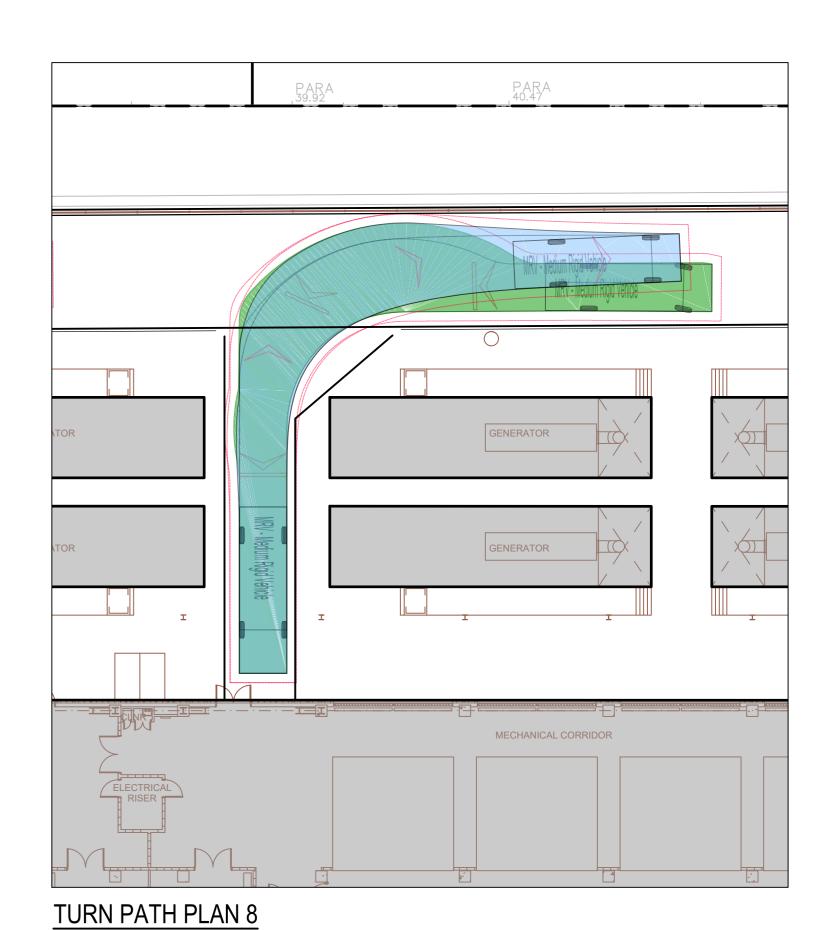

LOADBANK DRIVEWAY

8.8m MRV FORWARD AND REVERSE MANOEUVRE

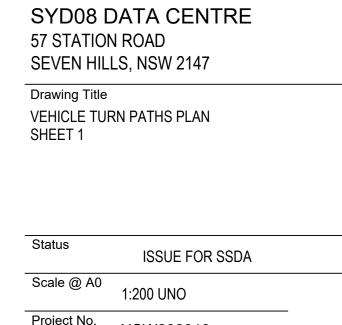

NSW202013\_C107.01

() LCI

Date By Chk

Lead Consultant / MEP / Structures

LCI CONSULTANTS (AUSTRALIA) PTY LTD

LCI CONSULTANTS (AUSTRALIA) PTY LTD

COMMERCIAL IN CONFIDENCE